

STUDIO VILOZ

DUPLEXCITY

East Liberty, Pittsburgh, PA 15206


OWNER

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GENERAL NOTES

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2. CONTRACTORS AND SUBCONTRACTORS SHALL VERIFY ALL FIGURED DIMENSIONS AND CONDITIONS AT THE JOBSITE AND NOTIFY THE ARCHITECT OF ANY DIMENSIONAL ERRORS, OMISSIONS OR DISCREPANCIES BEFORE BEGINNING OR FABRICATION OF ANY WORK. DO NOT SCALE THESE DRAWINGS.



ARCHITECT

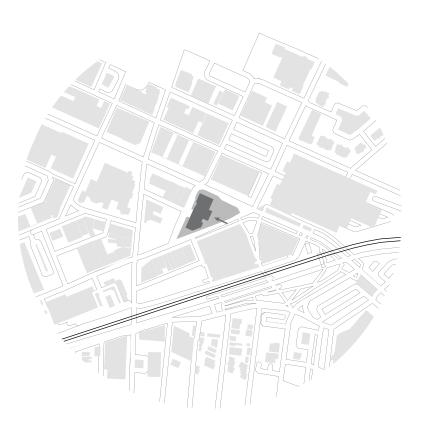STUDIO //i_OZ

5000 Forbes Avenue,
Pittsburgh, PA, US 15217

CONSULTANTS

Project No :

Drawn : Chitika V. Date : 1

Checked : Akhil B. Scale : N

Sheet Title : SHEET LIST

SHEET NO.	TITLE	SCALE
G-000	Cover Sheet	N/A
G-001	Sheet List	N/A
G-002	Code Summary	N/A
G-003	Sustainability Targets	N/A
A-001	Site Plan	1" = 20'
A-101	First Floor Plan	1/8" = 1'-0"
A-102	Second Floor Plan	1/8" = 1'-0"
A-103	Residential Floor Plans (Floors 3 & 4)	1/8" = 1'-0"
A-104	Residential Floor Plans (Floors 5 & 6)	1/8" = 1'-0"
A-105	Residential Floor Plans (Floors 7 & 8)	1/8" = 1'-0"
A-106	Residential Floor Plans (Floors 9 & 10)	1/8" = 1'-0"
A-107	Residential Floor Plans (Floors 11 & 12)	1/8" = 1'-0"
A-108	Residential Floor Plans (Floors 13 & 14)	1/8" = 1'-0"
A-109	Residential Floor Plans (Floors 15 & 16)	1/8" = 1'-0"
		4 / 4 4 6
A-151	Enlarged Unit Plans	1/4" = 1'-0"
A-152	Enlarged Unit Plans	1/4" = 1'-0"
A-201	Building Elevation (East)	1/8" = 1'-0"
A-202	Building Elevation (North and South)	1/8" = 1'-0"
A-203	Building Elevation (West)	1/8" = 1'-0"
A-301	Building Cross Section	1/8" = 1'-0"
A-302	Building Longitudanal Section	1/8" = 1'-0"
A-401	Systems Sheet: Site Details	Varies
A-402	Systems Sheet: Green Roof	Varies
A-403	Systems Sheet: Curtain Wall	Varies
A-404	Systems Sheet: Façade	Varies

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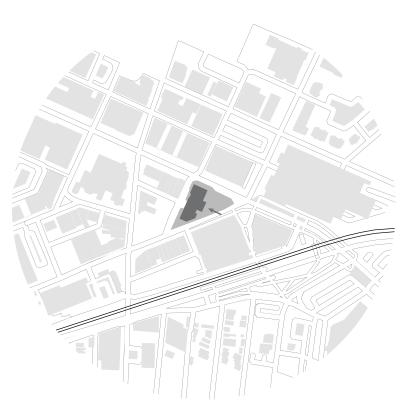
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5000 Forbes Avenue,
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Project No :

Drawn : Chitika V. Date : 12/09/2019

Checked : Akhil B. Scale : N/A

Sheet Title : SHEET LIST

TEM	ISSUE	CHAPTER/ARTICLE	ORDINANCE/ REQUIREMENT	ACTUAL	REMARKS
ning Requirer	ments				
	1.01 Zoning District		UNC 84-C-46 84-C-51		
	1.02 Lot Area		28,346 SF		
	1.03 Project F.A.R		10.0 Max		
	1.04 Building Area		283,460 SF		
			275'-0" Mx to underside of top habitable floor		
	1.05 Building Height		299'-0" Max overall height with reference from the public way		
			Sheridan Square		
			12'-0" required setback at cornice elevation of 100 Seridan Square bldg		
			10'-0" required setback at top floor elevation of Baum Sq parking garage		
			Penn Ave		
			15'-0" required setback at cornice elevation of 6101 Penn Ave bldg		
			25'-0" required setback at +150'-0" elevation		
			Centre Ave		
			5'-0" required setback at Grade		
			15'-0" required setback at roof elevation of East End Bond		
	1.06 Setbacks		20'-0" required setback at +180'-0" elevation		
			According to 914.10.A, the minimum off-street loading required for		
			multi-unit residential above 250,001 sqft is 4 loading zones.		
			Each required off-street loading space shall be a minimum of ten (10) feet		
		914.10.A	in width and twenty-five (25) feet in length, provided that a greater length		
		011.10.71	shall be required whenever necessary to ensure that no vehicle using the		
	1.07 Loading Zone	914.10.C.5	space extends beyond a property line.		

			Group R-2- Residential	
			Group B- Business	
	Occupancy Classification	310.1	Group M- Mercantile	
	Construction Type	601	Type I-A	
	Maximum Number of Stories			
	a) Group B		U.L.	
	b) Group R-2		U.L.	
	c) Group M	504.4	U.L.	
	Allowable Area			
	a) Group B		U.L.	
	b) Group R-2		U.L.	
	c) Group M	506.2	U.L.	
	Building Elements			
	a).Primary Structure Frame		3 HR	
	b).Bearing Wall Exterior		3 HR	
	c).Bearing Wall Interior		3 HR	
	d).Non Bearing Walls and Partitions Interior		0 HR	
	e). Floor Construction and Associated Secondary Members	601	2 HR	
	f).Roof Construction and Associates Secondary Members	601	1.5 HR	
	Fire Wall Fire-Resistance Ratings		3 HR	
	a) Group B		3 HR	
	b) Group R-2	706.4	3 HR	
	c) Group M	700.4	3 FIX	
	Fire Barriers Fire- Resistance Rating		2 HR	
	a) Group B		2 HR 2 HR	
	b) Group R-2 c) Group M	707.3.10	2 HR	
	·	707.3.10	Z FIK	
	Horizontal Building Seperation Allowances		>3 HR	Space helpsy the congretion and
}	a) Horizontal Seperation Spaceb) Shaft, Stairway, Ramp, Elevator Enclosure in the Space	510.2	>2 HR	Space below the seperation spa must be construction type1A.
)	b) Shart, Stall Way, Namp, Elevator Enclosure in the Space	420.2	Required between individual	must be construction type i.k.
)	Seperation Walls	708.1	dwelling units	
	Chute Enclosure	713.13.3	>1 HR	
		403.2.12		>2 HR for four or more stories.
	Shaft Enclosure	713.4	>2 HR/ >1HR w/ Sprinkler	>1 HR for less than four stories.
	Chair Endodaid	403.2.12	- 1.1. Communication	>2 HR for four or more stories.
	Elevator Enclosure	713.4	>2 HR/ >1HR w/ Sprinkler	>1 HR for less than four stories
			Vertical opening allowed with	3.2.2.2.2.2.2.2.3.3.3.3.3.3.3.3.3.3.3.3
	Escalator Opening	712.1.3	proper sprinkler systems	
	Fire Partition for Corridor	706.5	>1 HR	
		418.6	>2 HR	
	Storage			Occupancy B/ Occupancy M
	Storage Interior Wall and Ceiling Finish		Occupancy R-2	
	Interior Wall and Ceiling Finish		Occupancy R-2 Class B/ Class C w/ Sprinkler	
	Interior Wall and Ceiling Finish a) Interior exit stairway, ramp, and exit passageways		Class B/ Class C w/ Sprinkler	Class A/ Class B w/ Sprinkler
	Interior Wall and Ceiling Finish a) Interior exit stairway, ramp, and exit passageways b) Corridors and enclosure for egress		Class B/ Class C w/ Sprinkler Class B/ Class C w/ Sprinkler	Class A/ Class B w/ Sprinkler Class B/ Class C w/ Sprinkler
	Interior Wall and Ceiling Finish a) Interior exit stairway, ramp, and exit passageways	803.11 804.4.2	Class B/ Class C w/ Sprinkler	Class A/ Class B w/ Sprinkler

High-Rise Buil	ding			
3.01	Reduction in Fire-Resistance Rating	403.2.1.1	With proper sprinkler system, fire resistance rating can be reduced to the minimun.	
3.02	Sprayed Fire Resistant Materials(SFRM)	403.2.4	Bond strength >430psf	
				Sprinkler systems must connect to
3.03	Automatic Sprinkler System	403.3	Must contain automatic sprinkler systems	two water mains from different streets.
3.04	Emergency Systems	403.4	Must contain smoke detection and fire alarm systems	
3.05	Compartmentation	709.4	Not required w/ sprinkler system and fire-rated walls	
3.06	Fire Command Panel Location	911.1	Specified location approved by the fire department	
			Emergency voice systems should operate on the alarming floor and at least the	
3.07	Voice Communication Systems	907.5.2.2	floor below and below it.	
3.08	Mechanical Ventilation	910.2	Smoke ventilation is not required in spaces with sprinkler systems	
3.09	Stairwell Identification	1009.1	Directional signage provided at elevator landings, areas of refugee, and accessible egress	
3.10	Area of Rescue Assistance	1009.9	Appropriate signage complying with ICC A117.1 must be provided for areas of refugee	
		909.2		Stairway to roof must be through
3.11	Roof Access	IFC 1011.12	In buildings with four stories or more, one stairway shall extend to the roof	a smoke-proof enclosed space.

ITEM	ISSUE	CHAPTER/ARTICLE	ORDINANCE/CODE REQUIREMENT	ACTUAL	REMARKS
Frit De avrinement					
Exit Requirement	Remoteness of Interior		REQUIRED INTERIOR EXIT STAIRWAYS SEPARATED AT A MIN 30' DISTANCE OR		
4.01	Exit Stairways	403.5.1	NOT LESS THAN 1/4 OF LENGTH OF MAX. OVERALL DIAGONAL DIM.		
4.02	Stairway Communication System	403.5.3.1	REQUIRED TWO-WAY COM SYSTEM AT MIN EVERY FIFTH FLOOR		
			EACH FIRE SERVICE ACCESS ELEVATOR SHALL HAVE A CAPACITY		
4.05	Elevators	403.6.1	OF NOT LESS THAN 3500 LBS		
4.06	Number of Exits	405.7	EACH FLOOR SHALL BE PROVIDED A MIN. OF 2 EXITS		
			EVERY REQ. STAIRWAY SERVING FLOOR LEVELS MORE THAN 30' BELOW THE		
4.07	Smokeproof Enclosure	405.7.2	FINISHED FLOOR OF ITS LEVEL OF EXIT DISCHARGE SHALL COMPLY WITH REQ. SMOKEPROOF ENCLOSURE		
	Occupant Load Factor a) Group R-2 - Residential		200 Gross		
4.00	b) Group B - Business	4004.4	100 Gross		
4.08	c) Group M - Mercantile	1004.1	60 Gross		
4.09	Types of Exits	1002	TO EXTERIOR OCCURANT LOAD BED STORY 1 500: 2 MINI NUMBER OF EXITS		
	Minimum Number of Exits a) Group R-2 - Residential		OCCUPANT LOAD PER STORY 1-500; 2 MIN NUMBER OF EXITS ONE		
4 10	b) Group B - Business	1006.31	ONE ONE		
4.10.	c) Group M - Mercantile	1003.7	OI VL		
		1005.4 1005.7.1	NO OBSTRUCT. OR PROTRUDING OBJ. ANY EXIT		
	Arrangement &	1005.7.3	MIN WIDTH/REQ. CAPACITY SHALL NOT BE REDUCED OF TRAVEL		
4.11	Location of Exits Travel Distance to Exit	1020.3	UNTIL PUBLIC WAY		
	a) Group R-2 - Residentialb) Group B - Business				
4.12	c) Group M - Mercantile	1017.2	MAX. 200'; MAX. 250' WITH SPRINKLERS		
	Dead-end Corridors a) Group R-2 - Residential	SPACES WITH ONE EXIT OR EXIT			Exceptions: Building equipped with automatic sprinkler system, length
	b) Group B - Business	ACCESS DOORWAY	EXIT ACCESS WITH NO DEAD ENDS IN CORRIDORS MORE THAN		of the dead-end corridors shall be
4.13	c) Group M - Mercantile	1020.2	20' IN LENGTH		50' max.
	Exit Width				
	(Rel. to Largest Occupancy)				
4.14	a) Corridorb) Dwelling Unit	1020.2	MIN. 44" MIN. 36"		
4.15	Stair Capacity	1005.3.1	0.3* OCCUPANT LOAD		
4.16	Door Capacity				
4.10	Door Capacity				
4.17	Minimum Door Dimension	1010.1.1	32" MIN. CLEAR WIDTH 80" MIN HEIGHT		
4.18	Door Design Gen. Req's Landings	1010.1.2.1	SWING DIR. OF EGRESS TRAVEL		
	a) Min. Width		ACH MINI		
	b) Min Landing Lengthc) Max. Landing Reduction Due To		48" MIN. TRAVEL LENGTH		
	Door Swing	1010 1 5	LEVEL LANDING ON EACH SIDE OF A DOOR;		Eventions outside leadings 111
	d) Area of Refugee) Max. Vert. Dist. Between	1010.1.5 1010.1.6	LANDINGS SHALL HAVE AT LEAST THE SAME WIDTH OF THE STAIRWAY OR DOOR; AREA OF REFUGE SHALL BE SEPARATED FROM THE		Exceptions: exterior landings, which are permitted to have a max 2%
4.19	Landings	1009.6.4	REMAINDER OF THE STORY BY SMOKE BARRIER		slope.
		1003.3.1	80" MIN. NOT MORE THAN 50% OF CEILING AREA OF EGRESS SHALL BE REDUCED IN HEIGHT BY PROTRUDING OBJECTS;		
4.20.	Stair Headroom	1003.2	7'6" MIN. CEILING HEIGHT OF EGRESS		
4.21	Treads	1011.5	MIN. 11"		
4.22	Risers		MAX. 7" MIN. 4"		
4.22	Handrails	1012.8	RAMPS WITH RISE AT LEAST 6" SHALL HAVE HANDRAILS ON BOTH SIDES		
			SLOPED SURFACES FOR ELEVATION LESS THAN 12"; UNIFORM HEIGHT BETWEEN 34" AND 38";		
	Guardrails	ELEVAITION CHANGE	UNIFORM ALTERNATING TREAD DEVICES ABOVE TREAD		
	a) Heightb) Location	1003.5 1014.1	NOSINGS BETWEEN 30" AND 34"; PERMITTED TO EXCEED MAX. HEIGHT FOR CONTINOUS TRANSITION		
1	(N) EOOGHOIT	1014.1	BETWEEN FLIGHTS;		
	c) Exceptions			1	
4.24	c) Exceptions d) Graspability	1014.3	TYPE I CIRCULAR DIAMETER BETWEEN 1 1/4" AND 2"		
4.24	· ·		TYPE I CIRCULAR DIAMETER BETWEEN 1 1/4" AND 2"		
	d) Graspability	1014.3			
4.24 4.25 4.26	d) Graspability Grade Level Exit Req's Construction		MIN. 44" TYPE I-A		
4.25	d) Graspability Grade Level Exit Req's	1014.3	MIN. 44"		

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Drawn : Chitika V. Date : 12/09/2019

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Sheet Title : CODE SUMMARY



Y ? N

LEED v4 for BD+C: New Construction and Major Renovation

Project Checklist

Project Name: Duplexcity Apartments

Date: 12/09/2019

				Integrative Process	1
5	7	0	Loca	tion and Transportation	16
				LEED for Neighborhood Development Location	16
1				Sensitive Land Protection	1
1				High Priority Site	2
2	3			Surrounding Density and Diverse Uses	5
	3			Access to Quality Transit	5
	1			Bicycle Facilities	1
1				Reduced Parking Footprint	1

2	4	0	Susta	inable Sites	10
Υ				Construction Activity Pollution Prevention	Required
1				Site Assessment	1
	1			Site Development - Protect or Restore Habitat	2
1			·	Open Space	1
				Rainwater Management	3
	2			Heat Island Reduction	2
	1			Light Pollution Reduction	1

1	7	0	Water	Efficiency	11
Υ				Outdoor Water Use Reduction	Required
Y				Indoor Water Use Reduction	Required
Υ				Building-Level Water Metering	Required
	1		·	Outdoor Water Use Reduction	2
	6		·	Indoor Water Use Reduction	6
				Cooling Tower Water Use	2
1				Water Metering	1

10	14	7	Ener	gy and Atmosphere	33
Υ				Fundamental Commissioning and Verification	Required
Υ				Minimum Energy Performance	Required
Υ				Building-Level Energy Metering	Required
Υ				Fundamental Refrigerant Management	Required
6			·	Enhanced Commissioning	6
•	12	6		Optimize Energy Performance	18
1				Advanced Energy Metering	1
2				Demand Response	2
	2	1		Renewable Energy Production	3
1				Enhanced Refrigerant Management	1
				Green Power and Carbon Offsets	2

8	8 3		Materi	ials and Resources	13
Υ				Storage and Collection of Recyclables	Required
Υ				Construction and Demolition Waste Management Planning	Required
	3	1		Building Life-Cycle Impact Reduction	5
2			-	Building Product Disclosure and Optimization - Environmental Product Declarations	2
2				Building Product Disclosure and Optimization - Sourcing of Raw Materials	2
2				Building Product Disclosure and Optimization - Material Ingredients	2
2				Construction and Demolition Waste Management	2
			•		

4	5	4	Indoor	Environmental Quality	16
Υ				Minimum Indoor Air Quality Performance	Require
Υ				Environmental Tobacco Smoke Control	Require
1				Enhanced Indoor Air Quality Strategies	2
	2	1	·	Low-Emitting Materials	3
1				Construction Indoor Air Quality Management Plan	1
	1	1		Indoor Air Quality Assessment	2
1				Thermal Comfort	1
	1	1		Interior Lighting	2
	1	1		Daylight	3
1			-	Quality Views	1
				Acoustic Performance	1

1	0	0	Innovation	6
			Innovation	5
1			LEED Accredited Professional	1

2	2	0	Regional Priority	4
1			Regional Priority: High Priority Site	1
1			Regional Priority: Enhanced Indoor Air Quality Strategies	1
	1		Regional Priority: Building Life Cycle Impact Reduction	1
	1		Regional Priority: Renewable Energy Production	1

33 42 12 75

Certified: 40 to 49 points, Silver: 50 to 59 points, Gold: 60 to 79 points, Platinum: 80 to 110



1.1	Integra	ited Design Process (IDP)	9
1.1	1.1.1	Pre-Design Meetings	3
	1.1.1	IDP Performance Goals	3
	1.1.2	IDP Progress Meeting for Design	3
	1.1.3	Capital Asset Plan & Business Case Summary (Federal only)	0
1.2		nmental Management During Construction	12
1.2	1.2.1	Environmental Management Systems (EMS)	3
	1.2.1	Clean Diesel Practices	2
	1.2.3	Building Materials and Building Envelope	2
	1.2.4	IAQ During Construction	5
1.3		issioning	29
	1.3.1	Pre-Commissioning	3
	1.3.2	Whole Building Commissioning	19
	1.3.3	Training	1
	1.3.4	Operations and Maintenance Manual	6
2.1	Develo	pment Area	30
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• -	2.1.2	Greenfields, Brownfields and Floodplains	20
2.2	_	ical Impacts	32
	2.2.1	Site Disturbance and Erosion	8
	2.2.2	Tree Integration	5
	2.2.3	Tree Preservation	4
	2.2.4	Heat Island Effect	13
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2.5		r Light Pollution	7
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	3.4.2	Orientation	5
	3.4.3	Fenestration Systems	16
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	3.5.2	Interior Automatic Light Shut-off Controls	3
	3.5.3	Light Reduction Controls	4
	3.5.4	Daylighting Controls for Daylighted Zones	8
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٠.٠	3.6.1	Building Automation System	10
	3.6.2	Cooling Equipment	13
	3.6.3	Cooling Towers	8
	3.6.4	Heat Pumps	6
	3.6.5	Heating Equipment	8
	3.6.6	Condensate Recovery	3
	3.6.7	Steam Traps	2
	3.6.8	Domestic Hot Water Heaters	3
	3.6.9	Variable Speed Control of Pumps	6
3.7	Other I	HVAC Systems and Controls	32
	3.7.1	Minimizing Re-heat and Re-cool	6
	3.7.2	Air Economizers	3
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	3.7.4	Demand Controlled Ventilation	10
	3.7.5	Variable Refrigerant Flow Systems	6
		Energy Efficient Equipment and Measures	11
3.8	3.8.1	Elevators and Escalators	5
3.8	3.8.2	Other Energy Efficient Equipment	6
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	Renew		
	3.9.1	On-site Renewable Energy	32
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4.2	Cooling		9
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4.4		tensive Applications	18
	4.4.1	Commercial Food Service Equipment	6
	4.4.2 4.4.3	Laboratory and Medical Equipment Laundry Equipment	5 4
	4.4.4	Special Water Features	3
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4.6	Alternat	e Sources of Water	5
4.7	Meterin	g	11
4.8	Irrigatio	n	18
5.1 5.2	_	Assembly (Core & Shell including Envelope)	33 16
5.2 5.3		Fit-Out (including Finishes and Furnishings) f Existing Structures	26
J.J	5.3.1	Facades	6
	5.3.2	Structural Systems	6
	5.3.3	Non-Structural Elements	14
5.4	Waste		9
	5.4.1	Construction Waste	7
	5.4.2	Operational Waste	2
5.5	_	Service Life Plan	7
5.6		e Conservation	6
	5.6.1	Minimized Use of Raw Materials	3
	5.6.2	Multi-Functional Assemblies	1
c -	5.6.3	Deconstruction and Disassembly Envelope Peofing/Openings	2
5.7	Building 5.7.1	Envelope - Roofing/Openings Roofing Membrane Assemblies and Systems	10 3
	5.7.1	Flashings	3
	5.7.3	Roof and Wall Openings	4
5.8		e - Foundation, Waterproofing	6
	5.8.1	Foundation Systems	4
	5.8.2	Below Grade Wall Slabs and Above Grade Horizontal	2
5.9	Envelop	e - Cladding	5
	5.9.1	Exterior Wall Cladding Systems	3
	5.9.2	Rainscreen Wall Cladding	2
5.1	Envelop	e - Barriers	7
	5.10.1	Air Barriers	4
	5.10.2	Vapor Retarders	3
6.1	Heating		18
6.2	Cooling		29
	6.2.1	Use of New or Existing Cooling Equipment (informational	0
	6.2.2	Ozone-Depleting Potential	10
	6.2.3	Global Warming Potential	10
	6.2.4	Leak Detection	9
6.3	Janitoria	ll Equipment	3
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	7.1.1	Ventilation Air Quantity	11
	7.1.2	Air Exchange	8
	712	Ventilation Intellege and Educate	_
	7.1.3	Ventilation Intakes and Exhausts	8 5
	7.1.4 7.1.5	CO2 Sensing and Ventilation Control Equipment Air Handling Equipment	5 5
7.2		Control and Measurement of Indoor Pollutants	46
	7.2.1	Volatile Organic Compounds	10
	7.2.2	Leakage, Condensation and Humidity	8
	7.2.3	Access for HVAC Maintenance	4
	7.2.4	Carbon Monoxide Monitoring	4
	7.2.5	Wet Cooling Towers	2
	7.2.6	Domestic Hot Water Systems	2
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7.5.1 Acoustic Comfort Design

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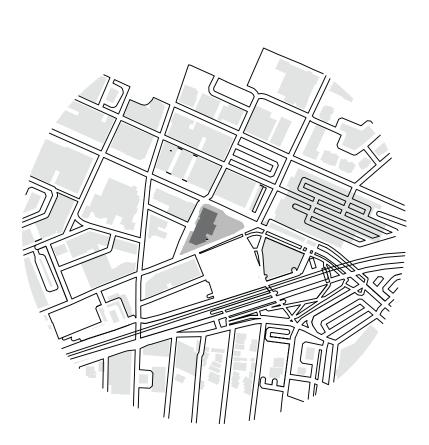
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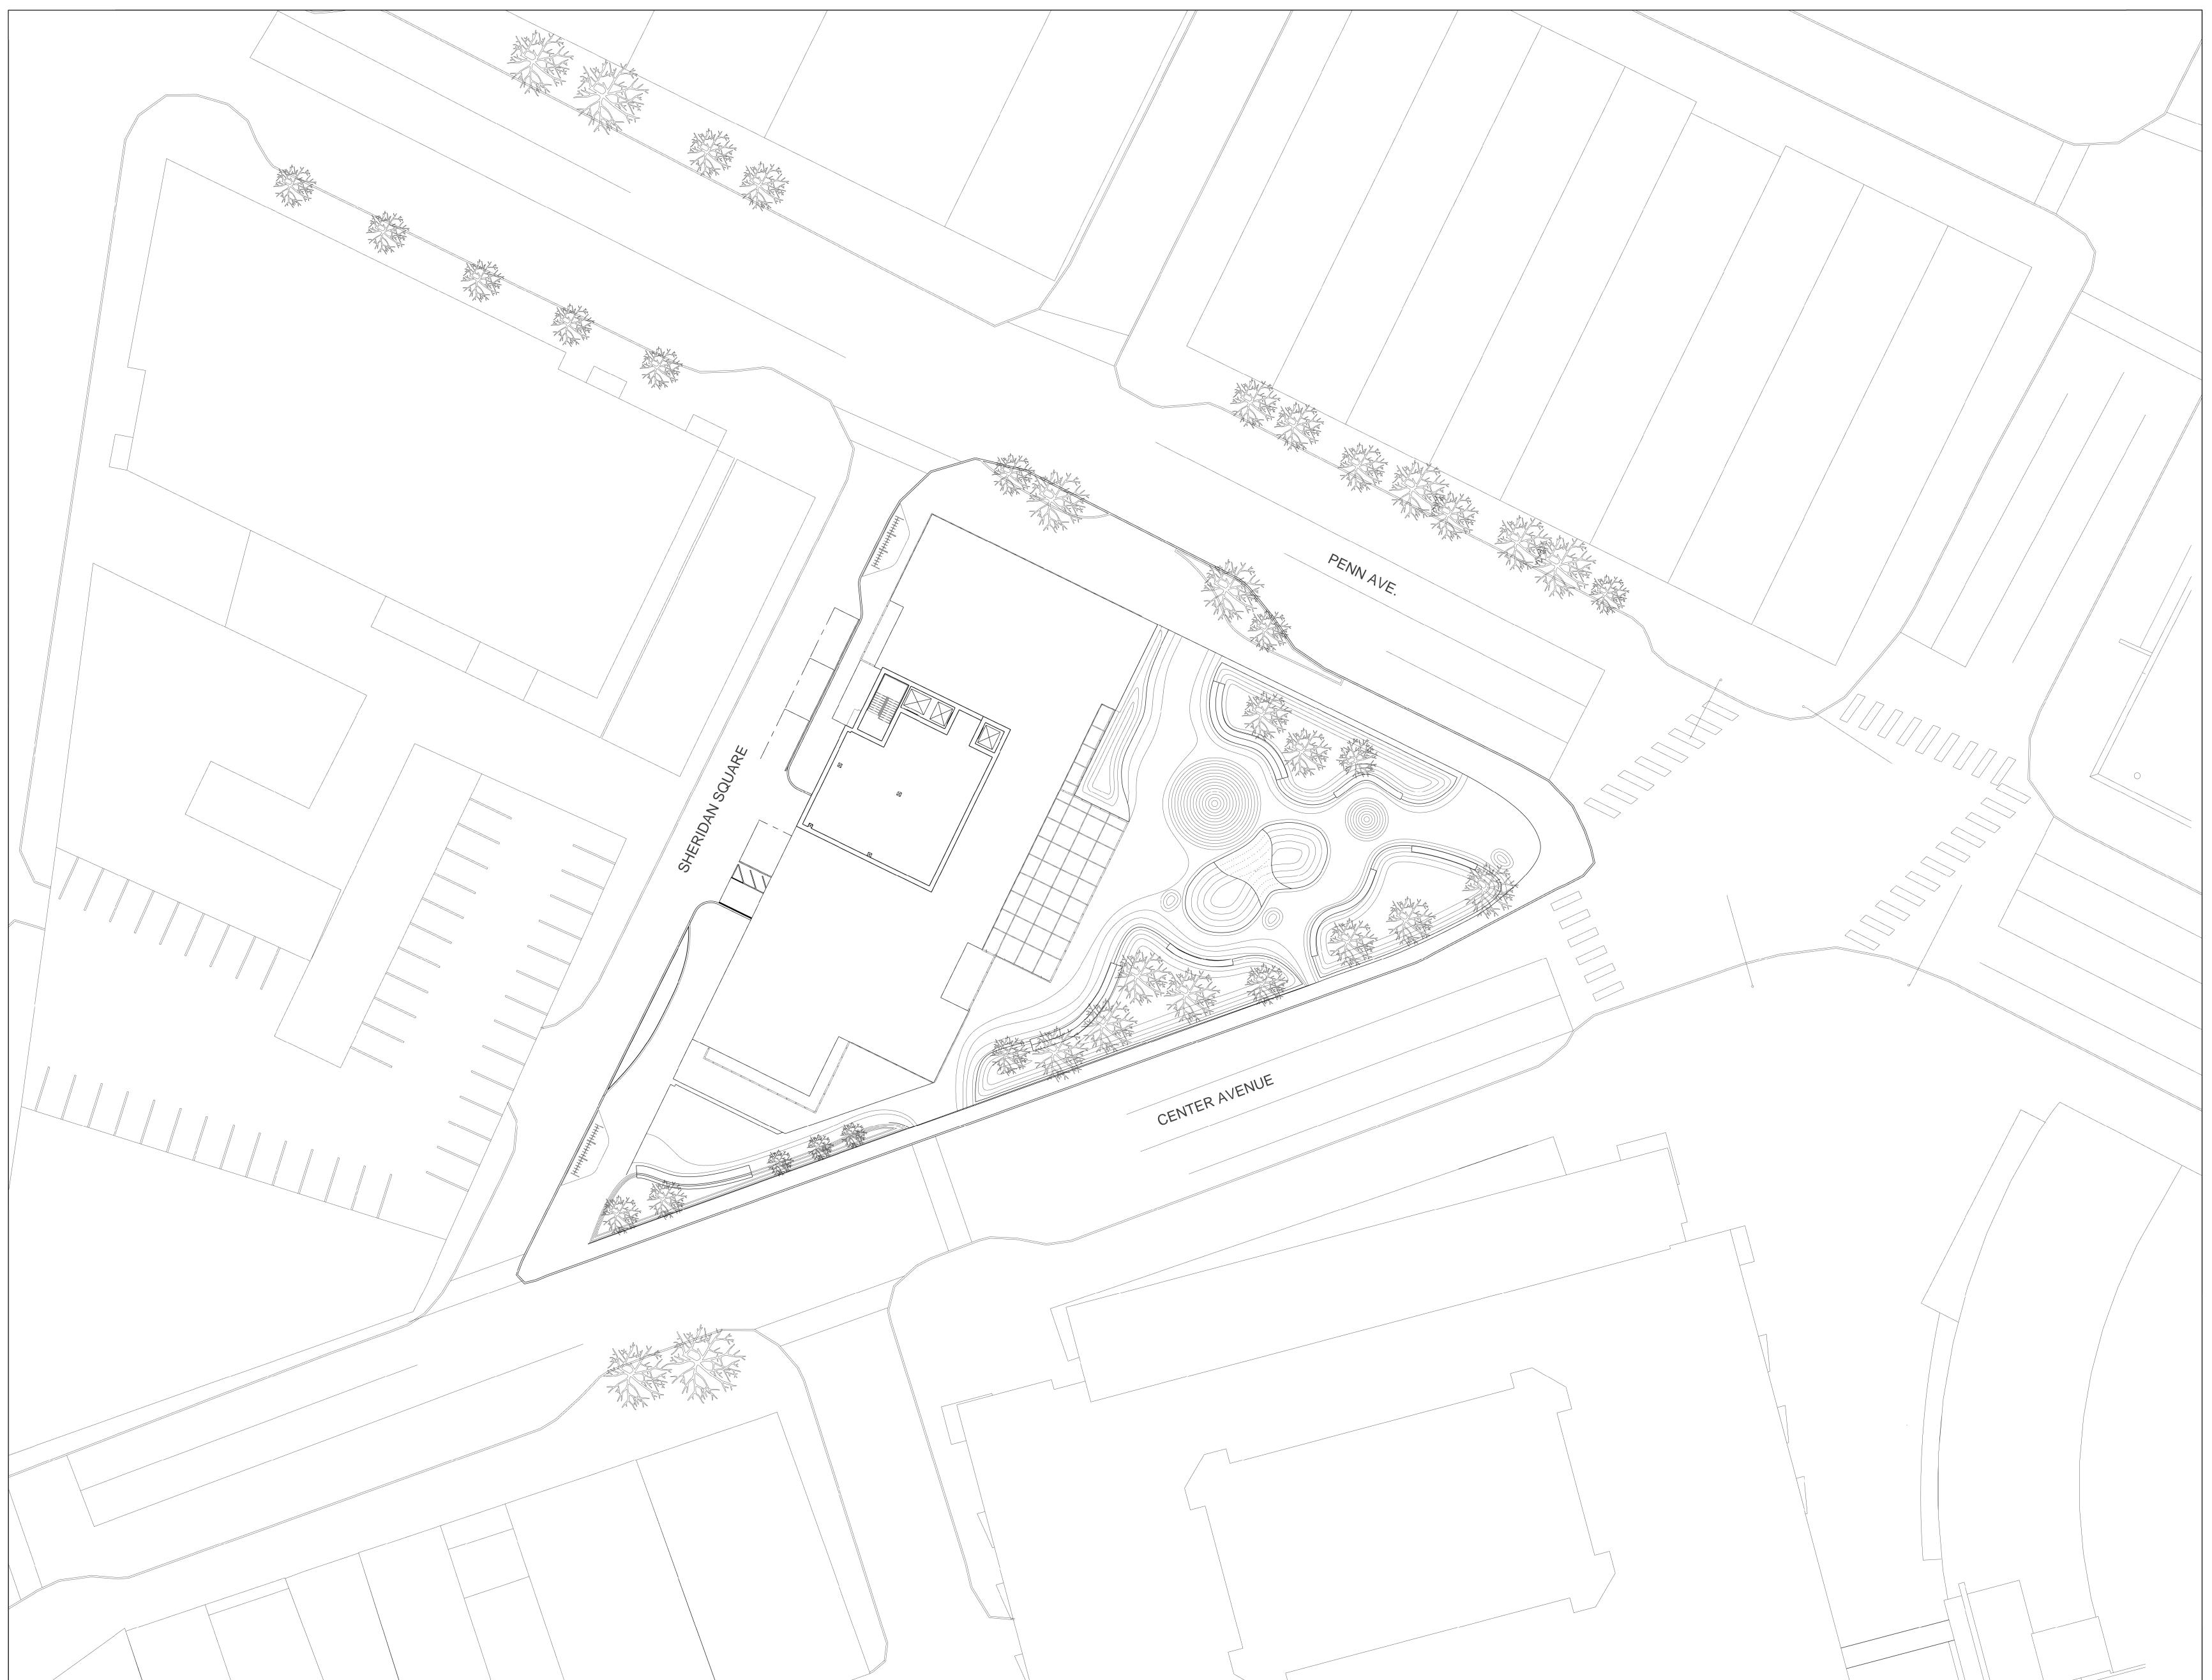
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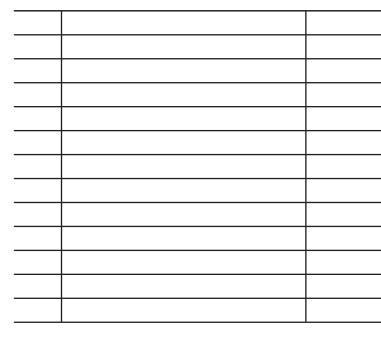
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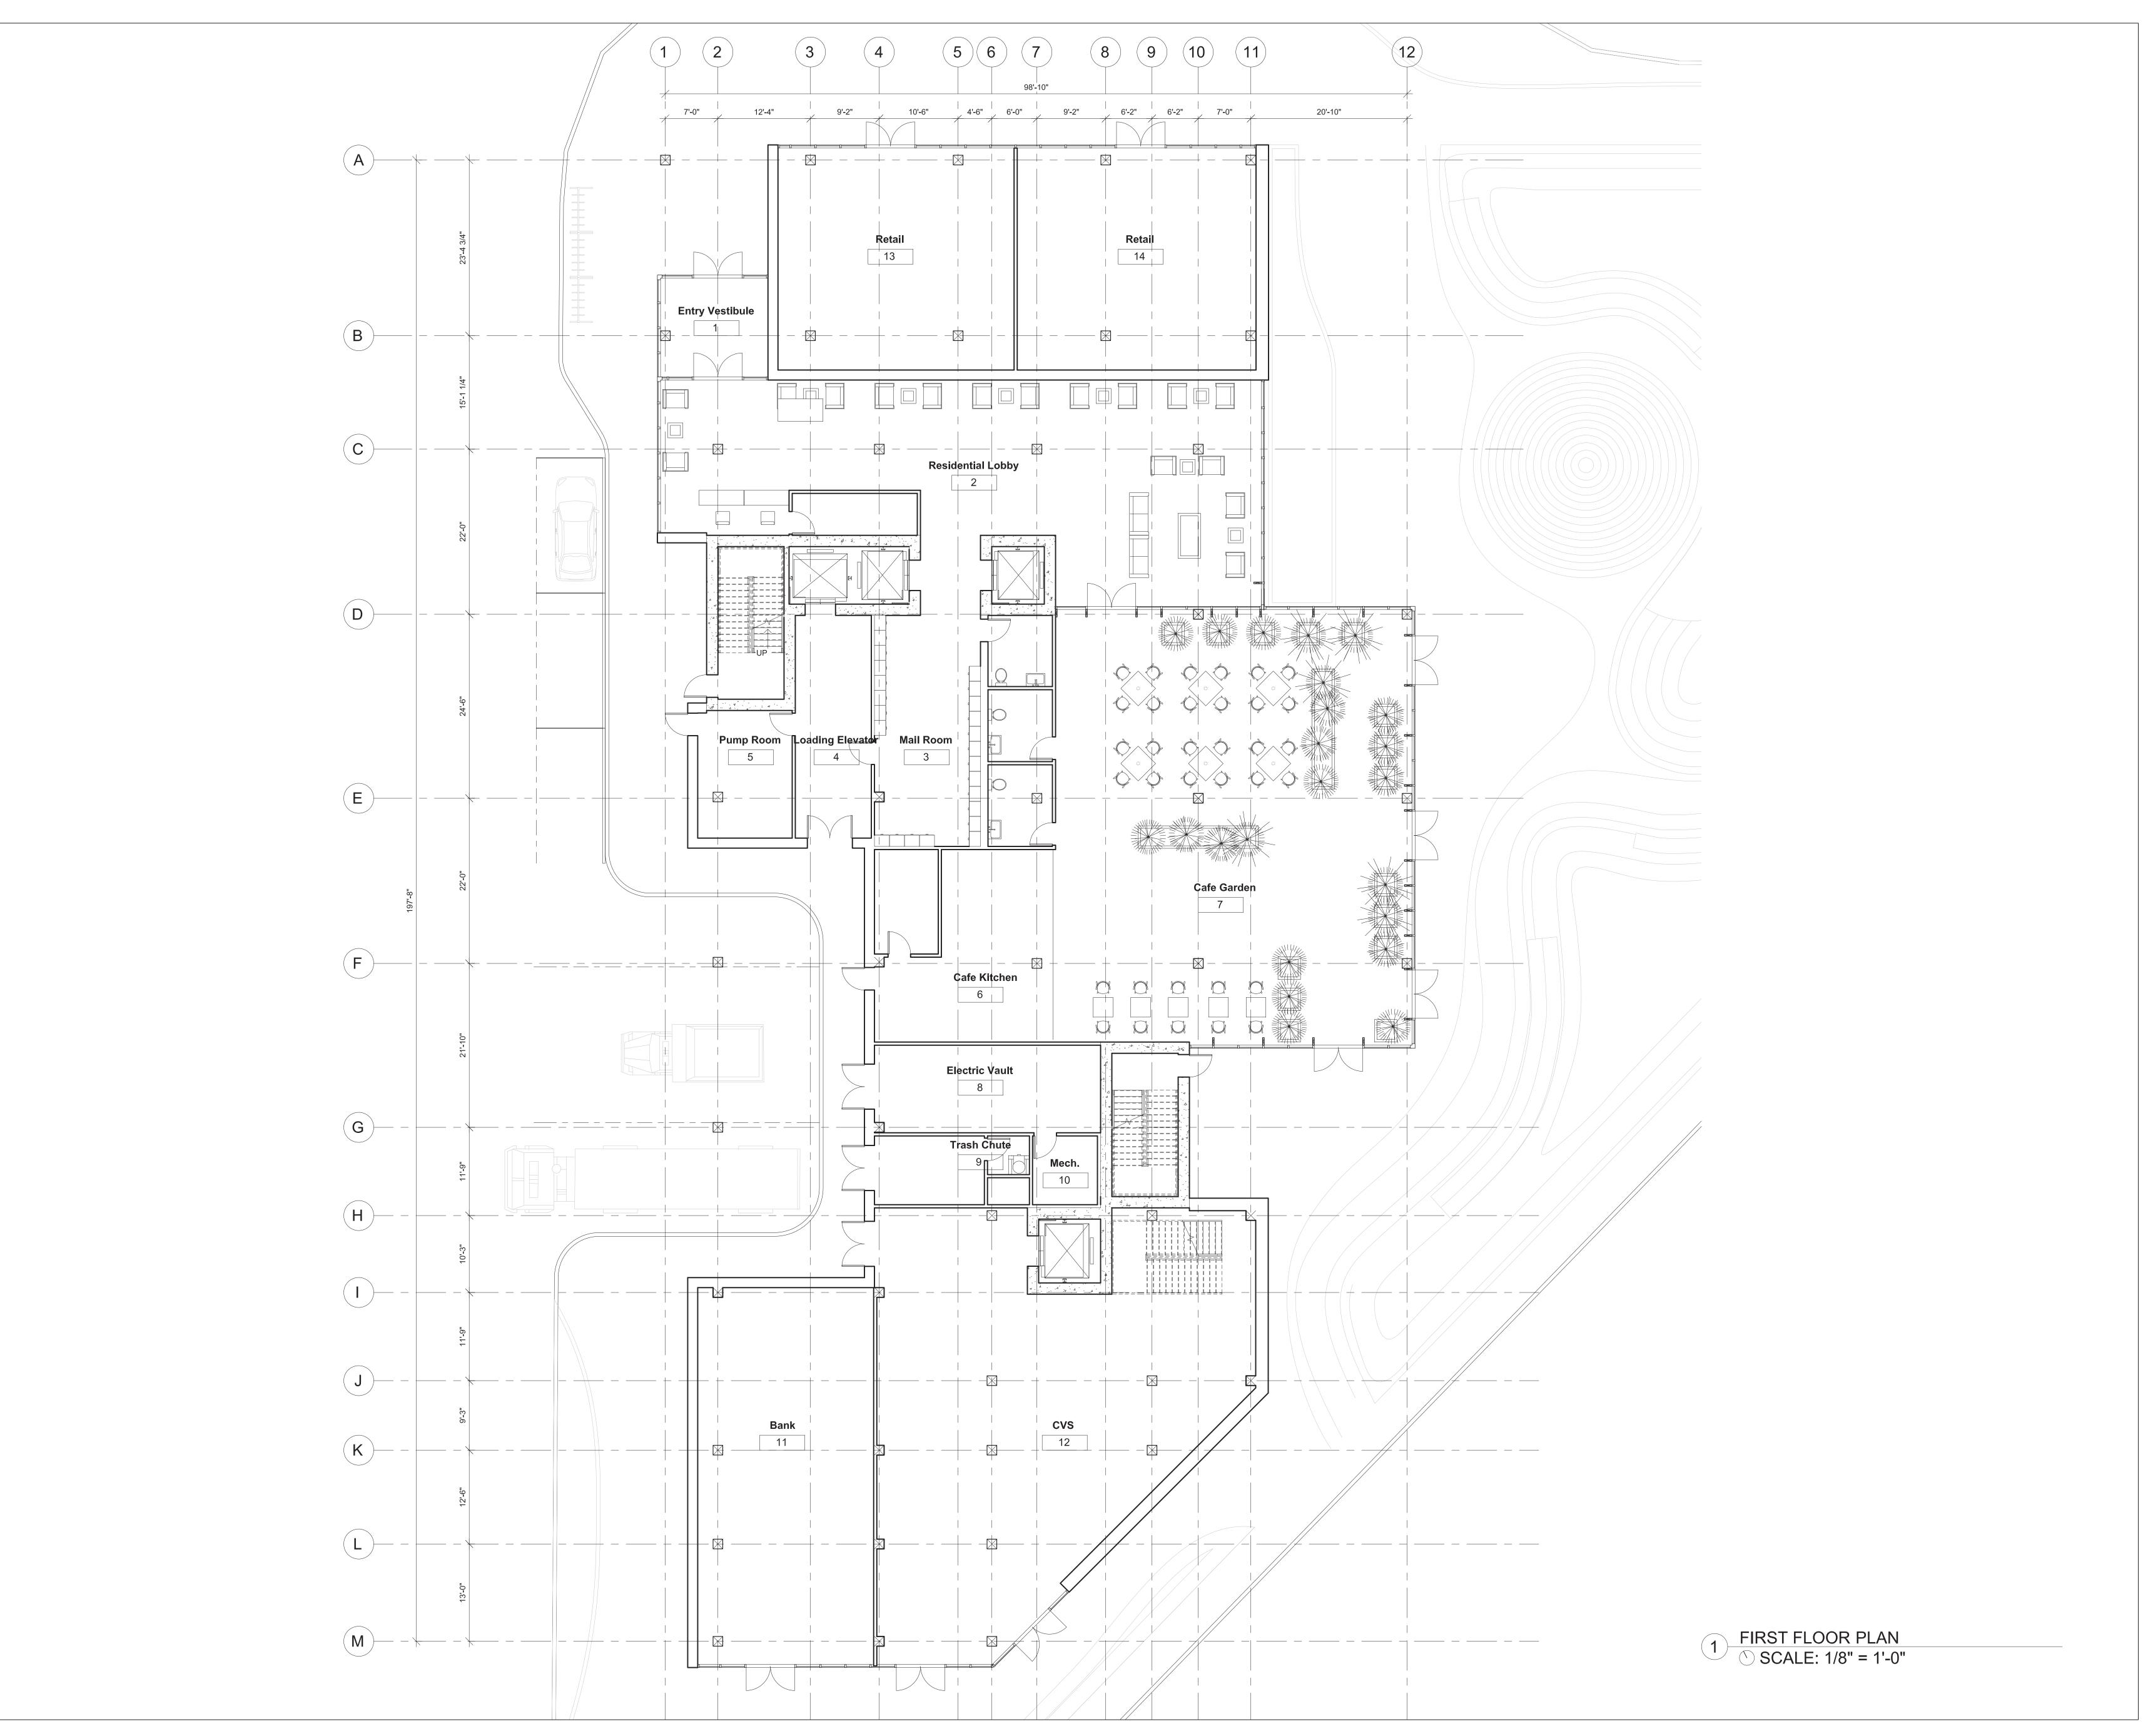
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Sheet Title: SITE PLAN



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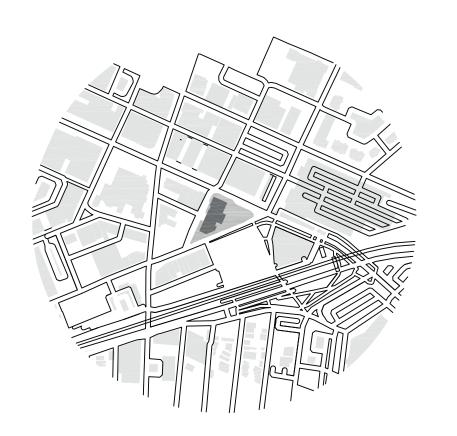
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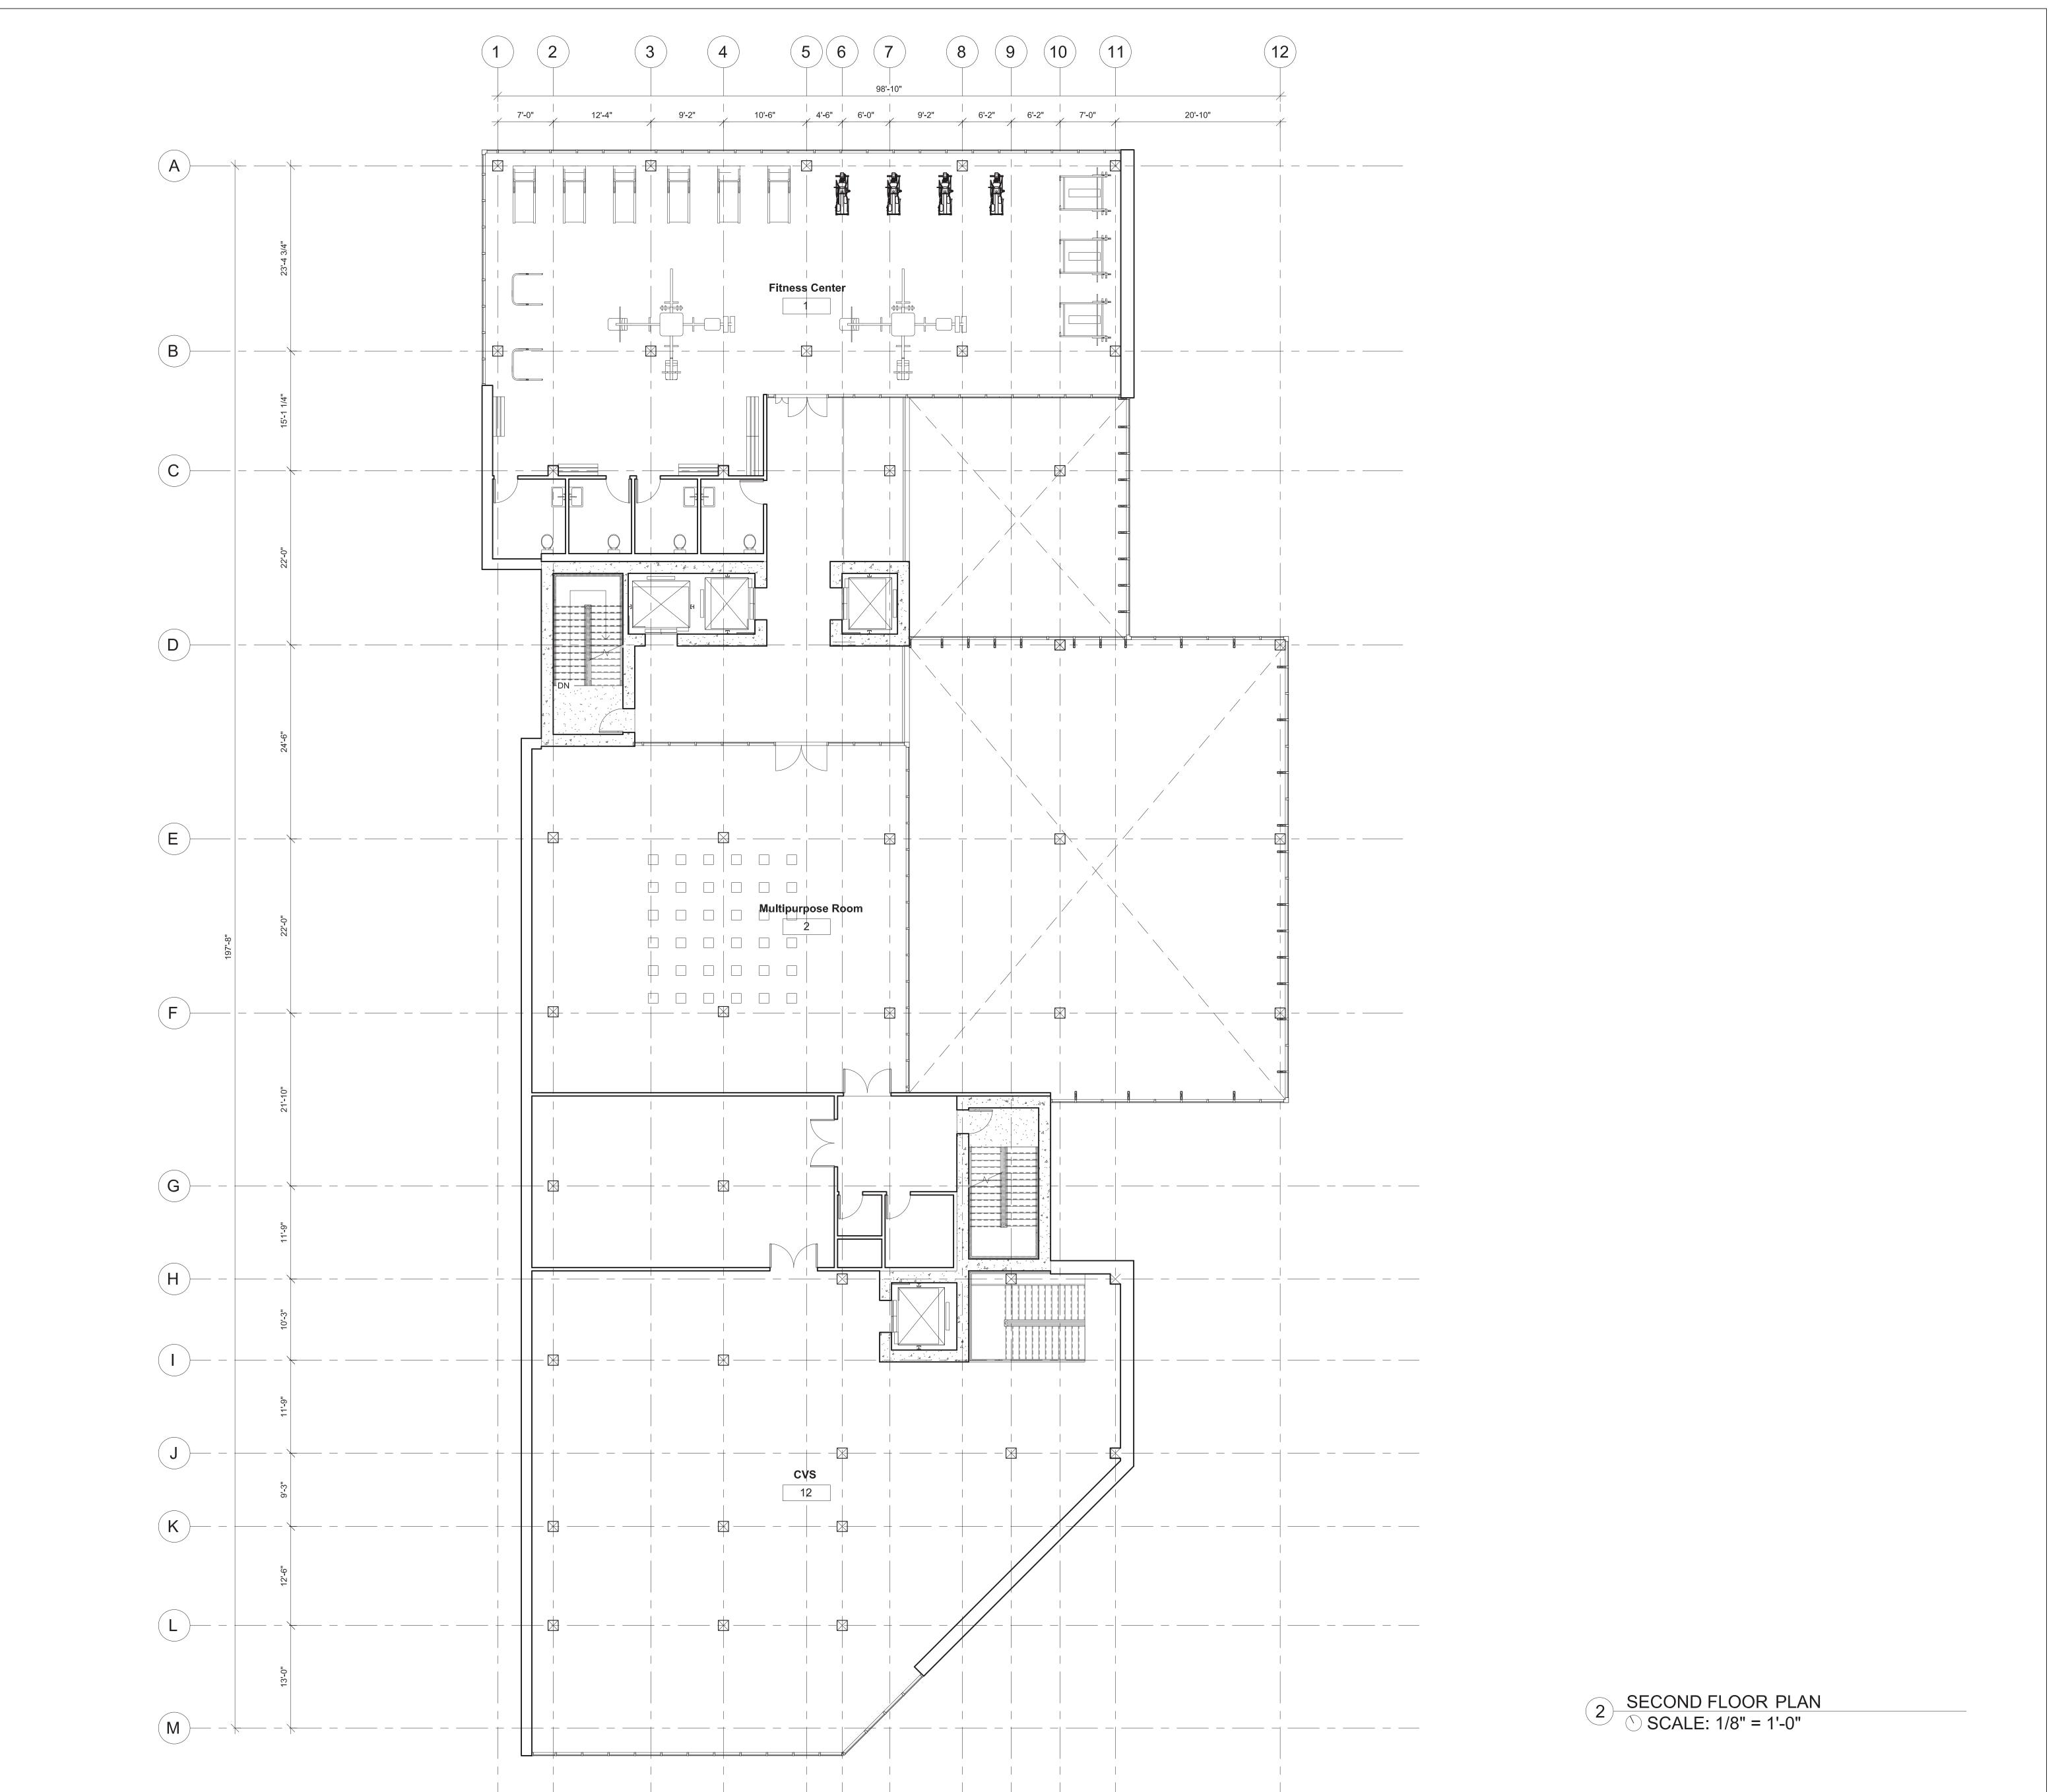
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Sheet Title: FIRST FLOOR PLAN



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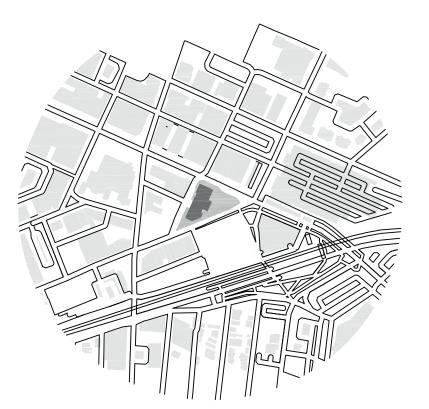
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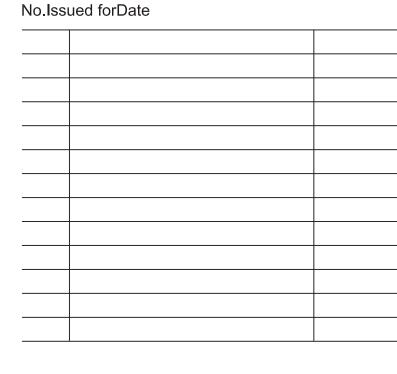
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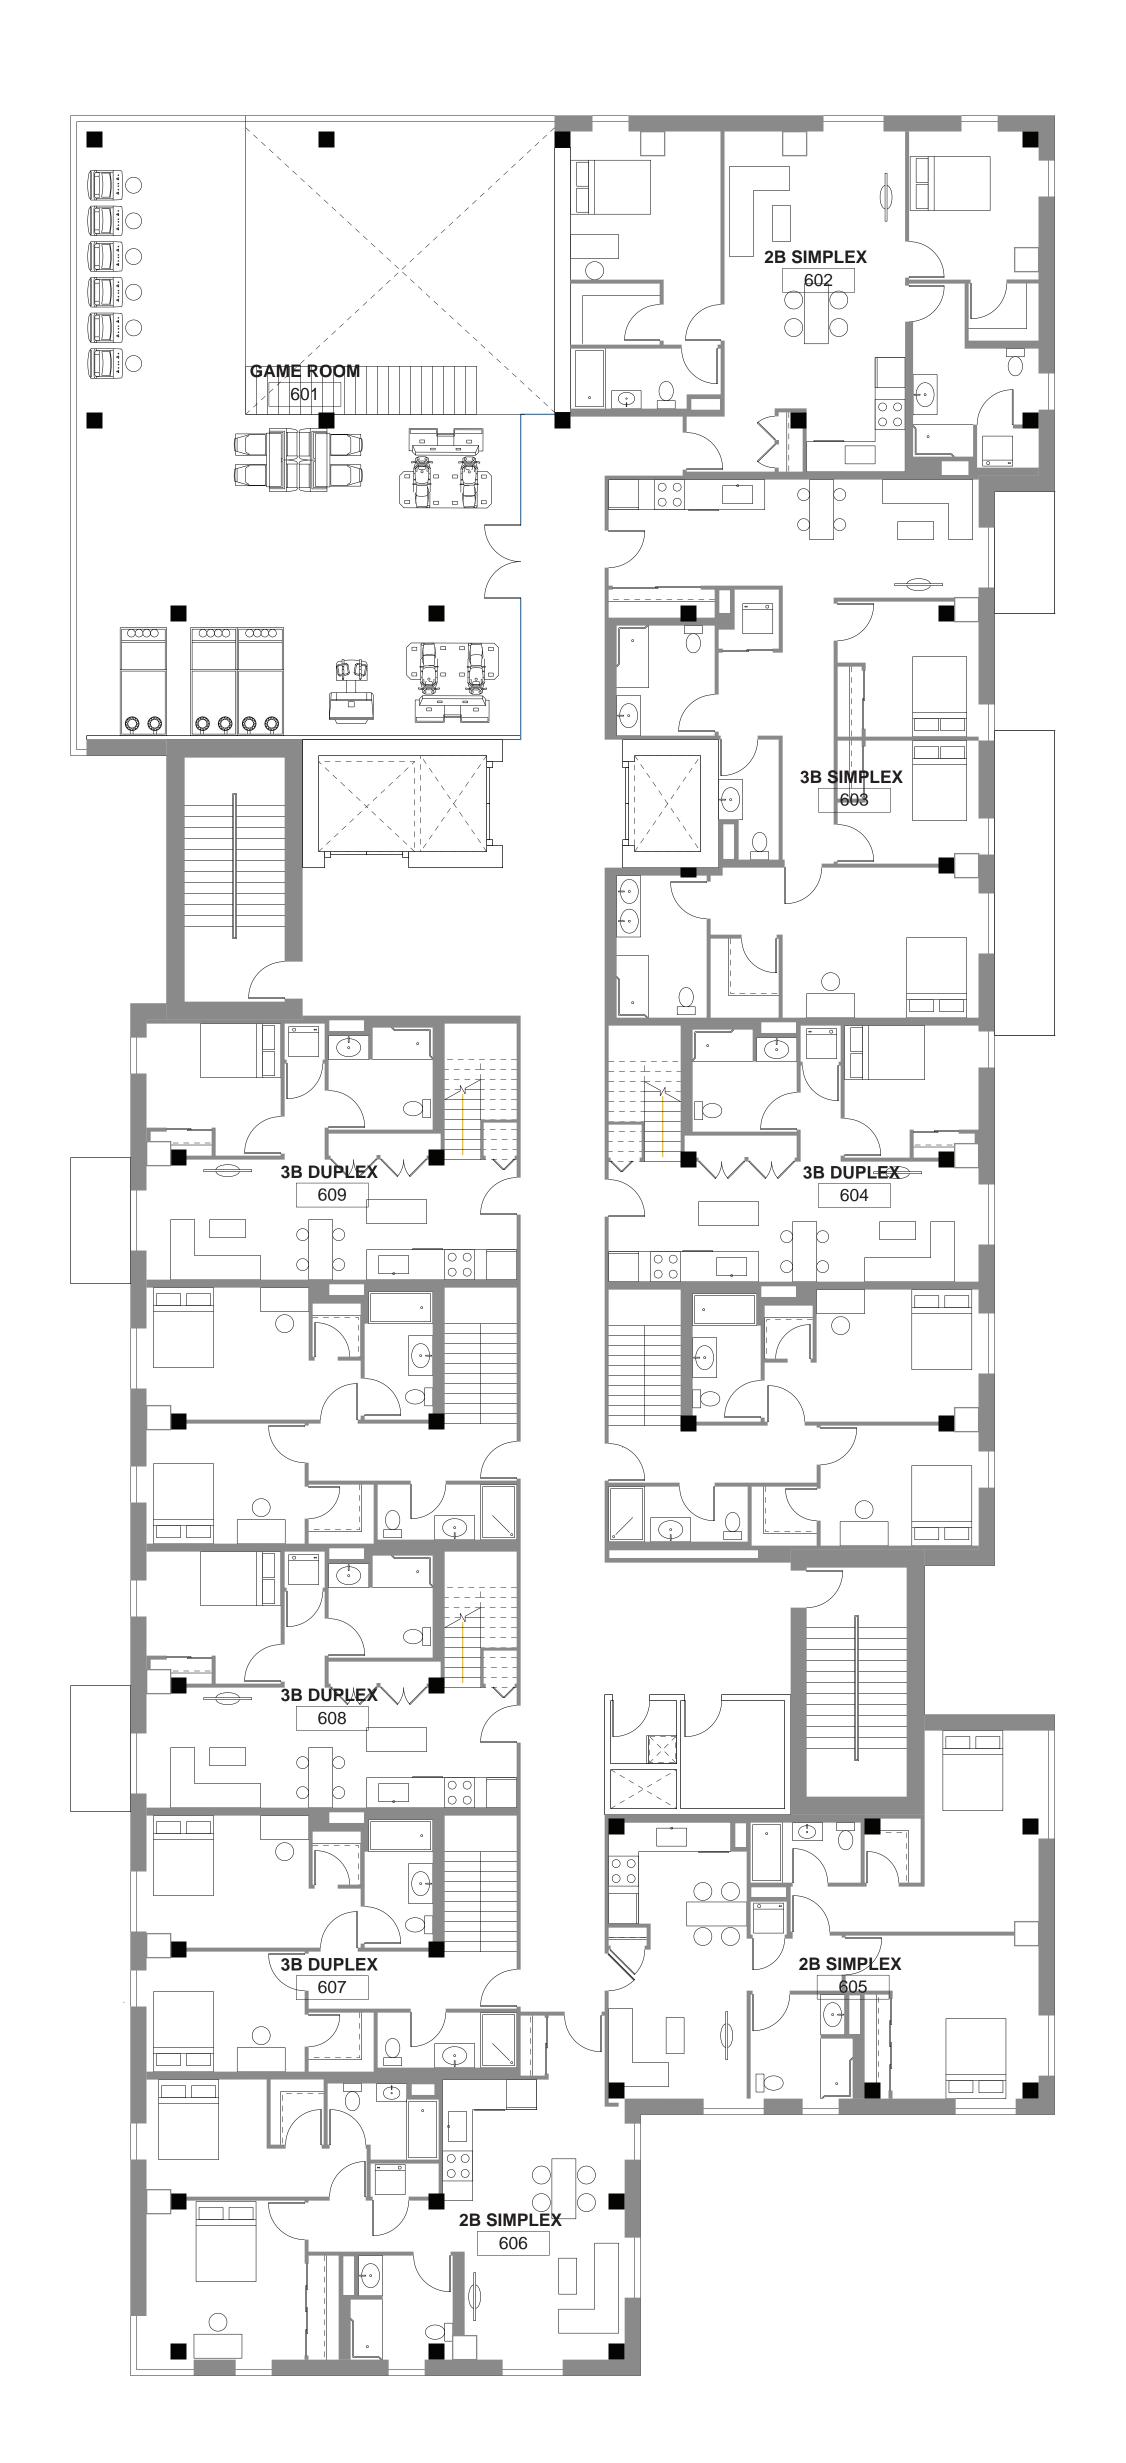
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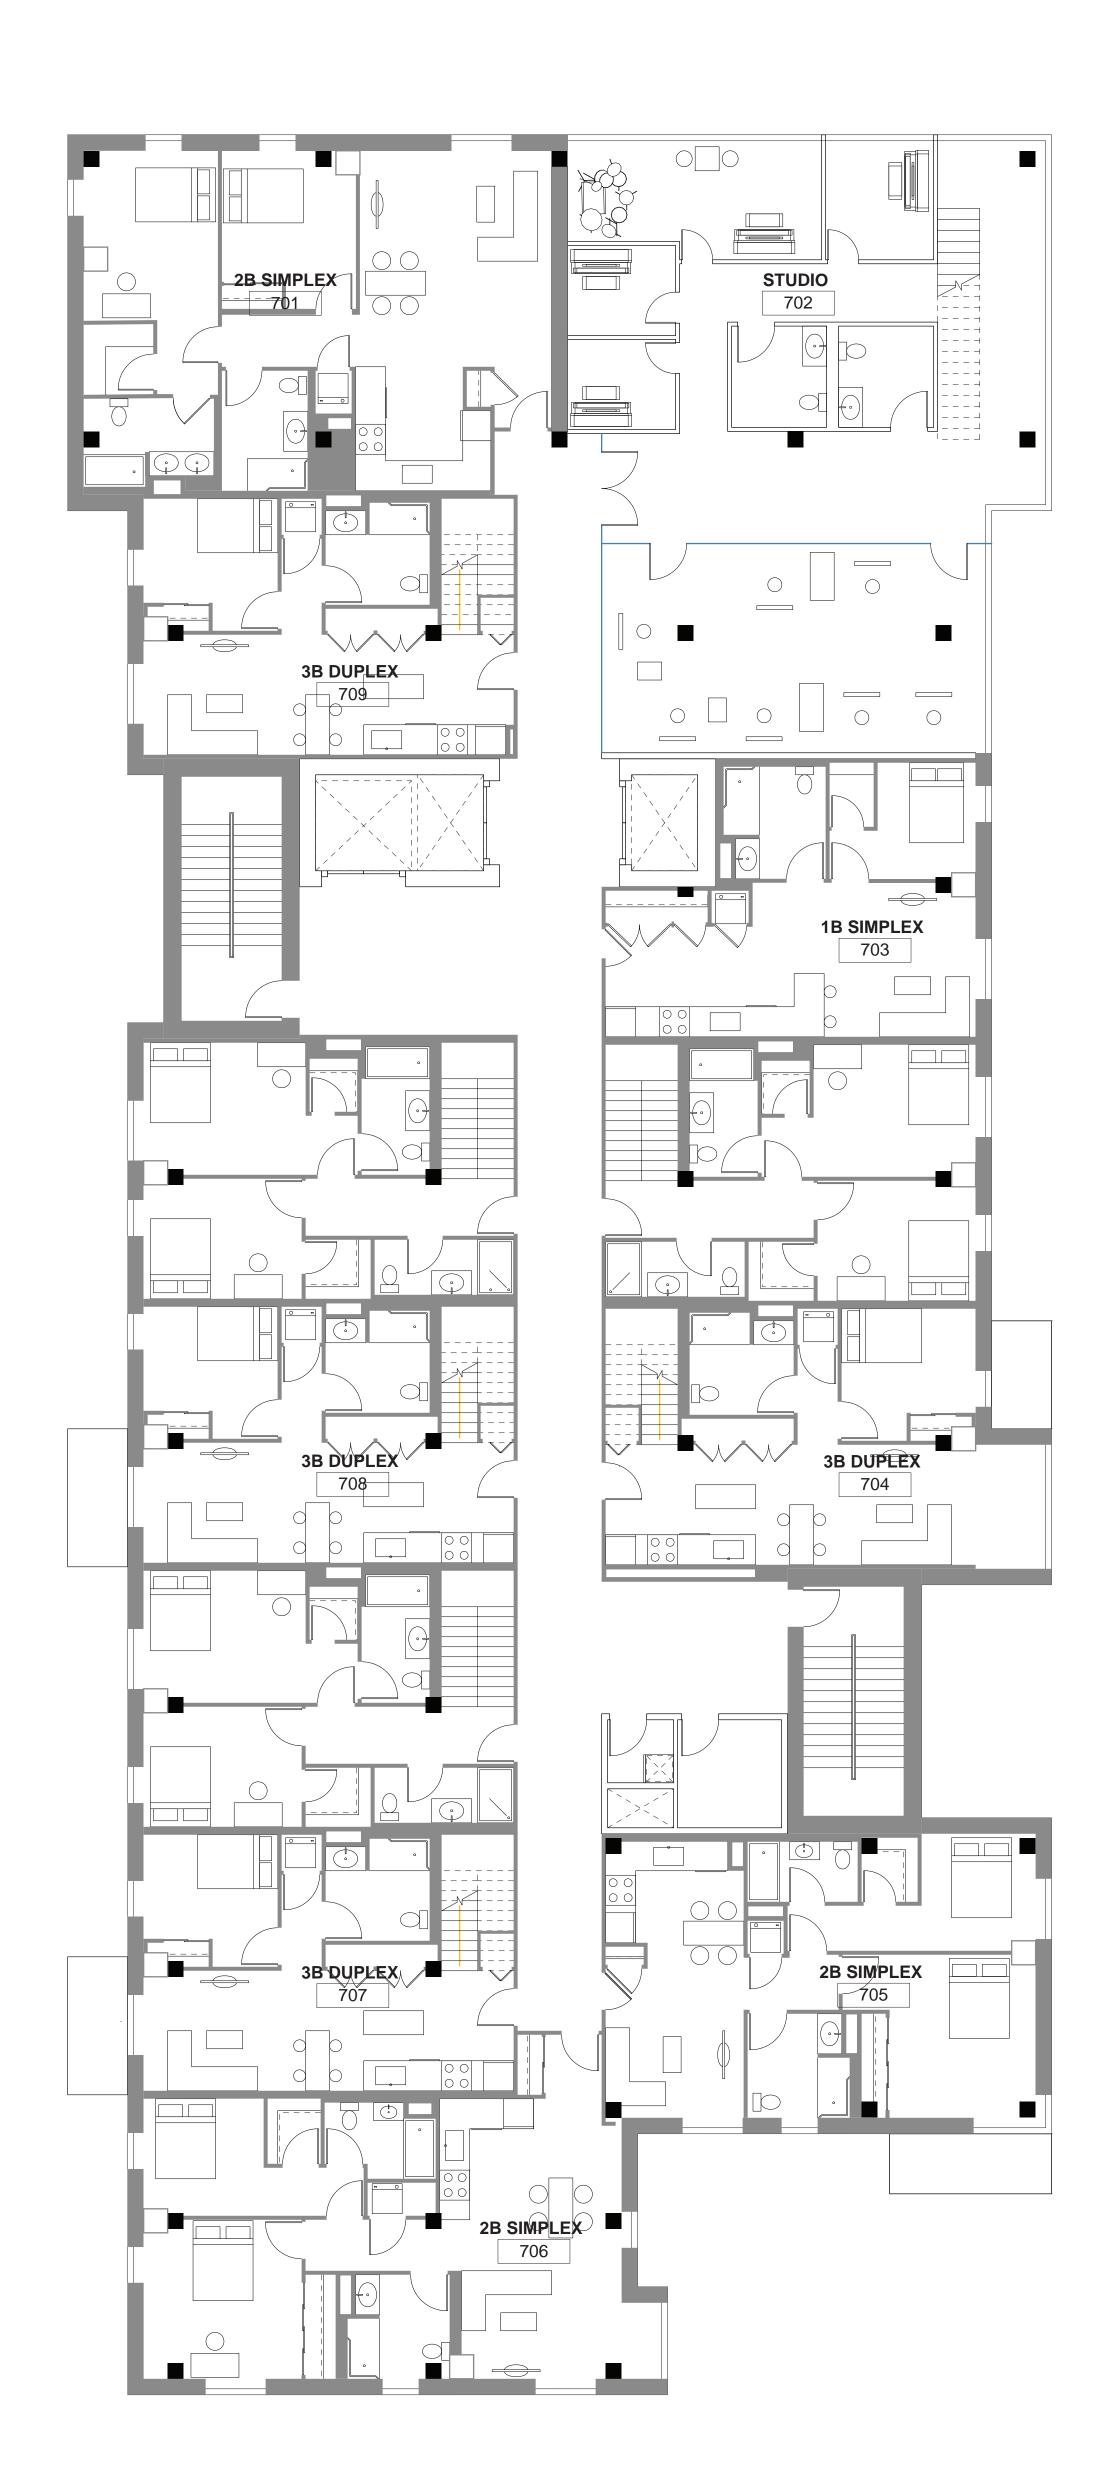
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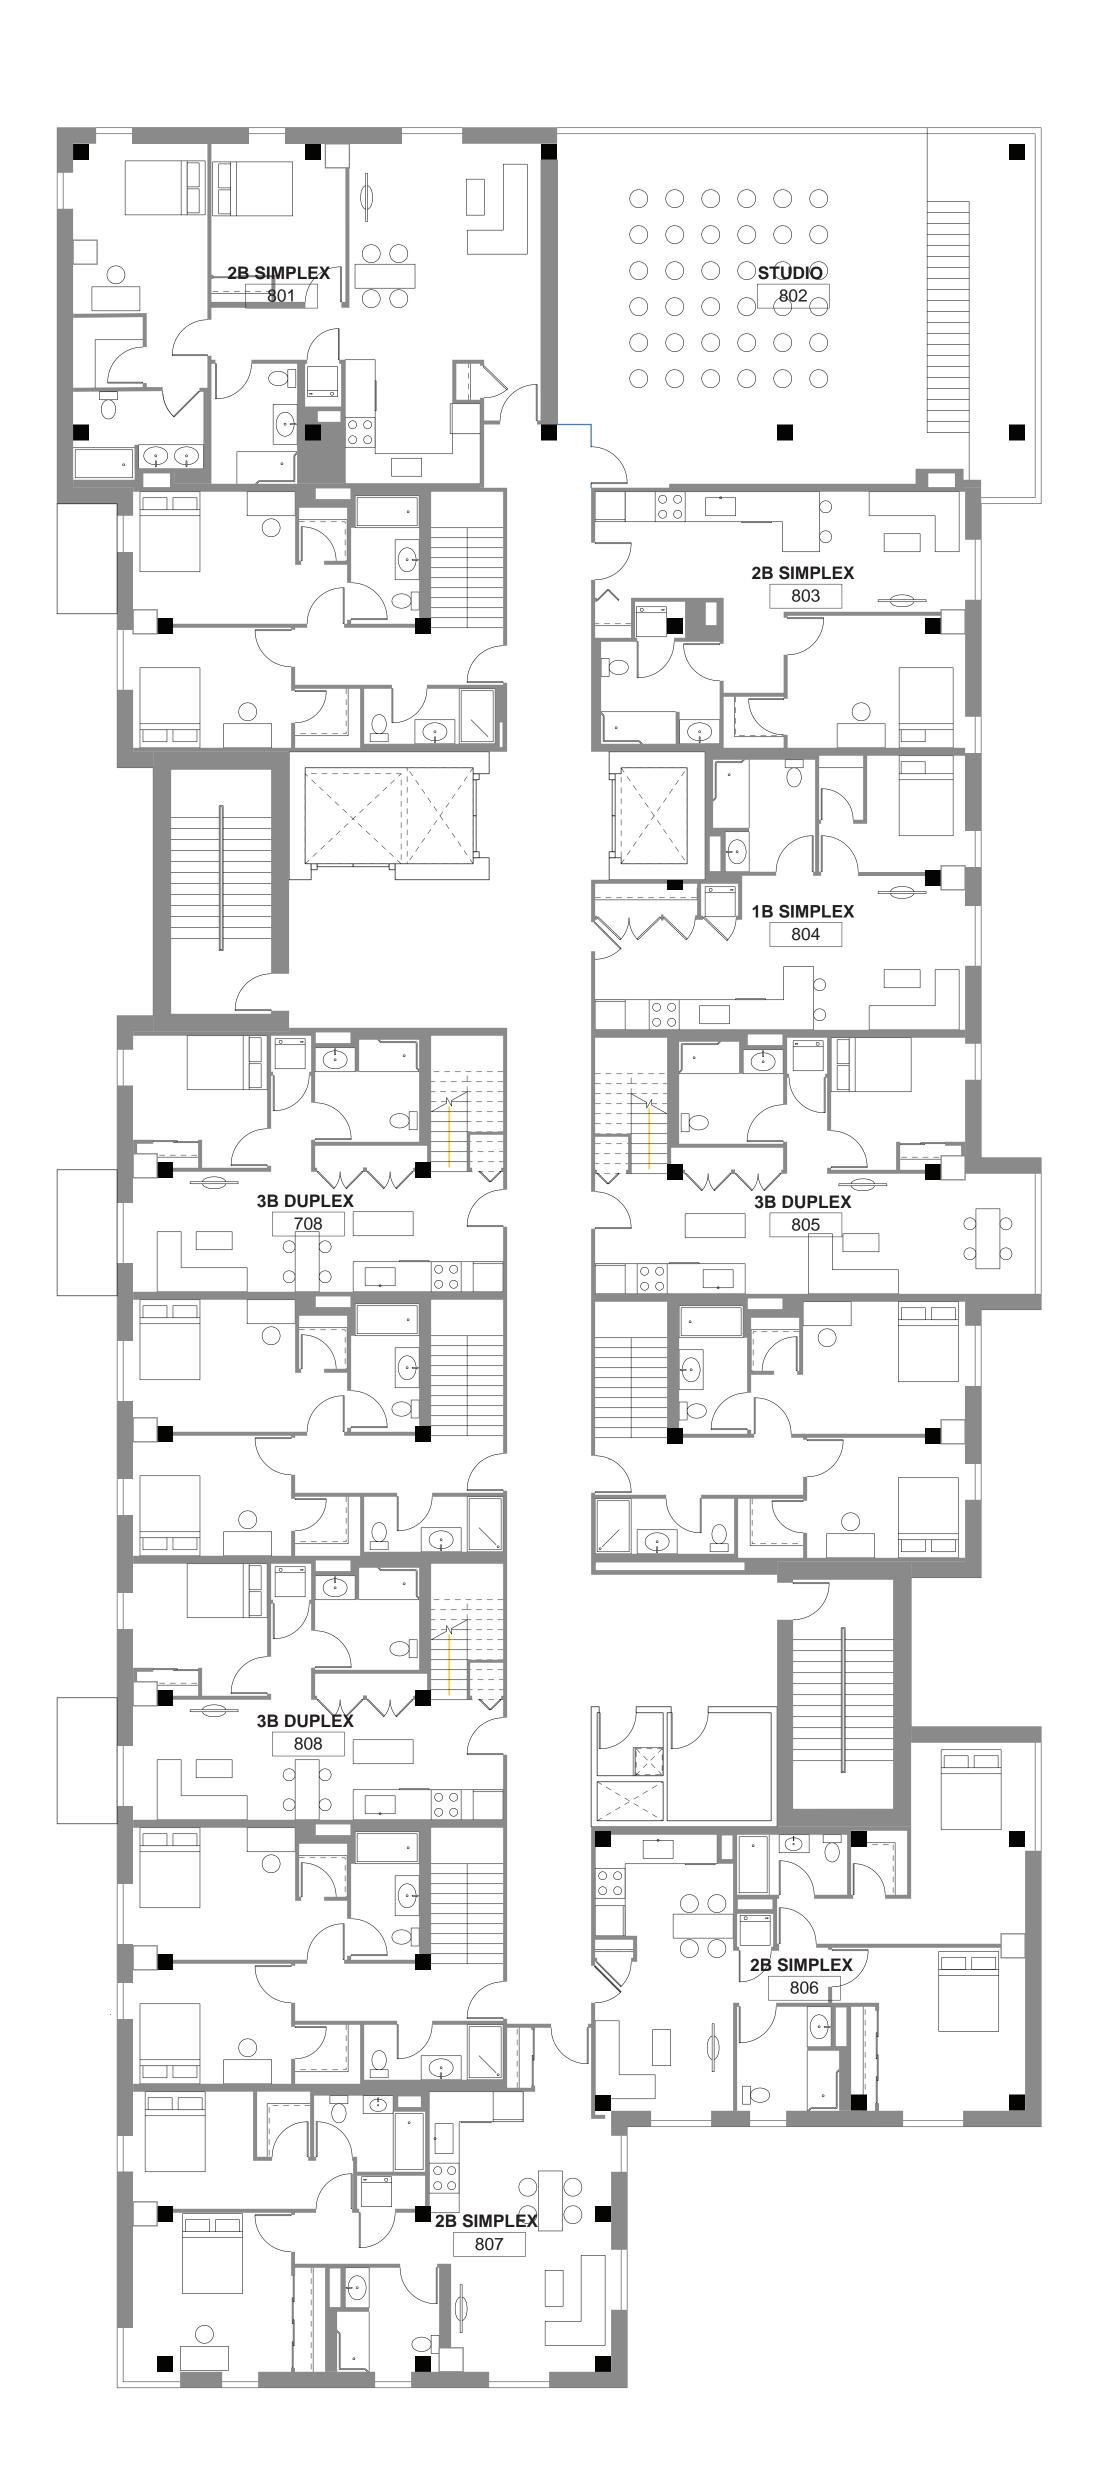
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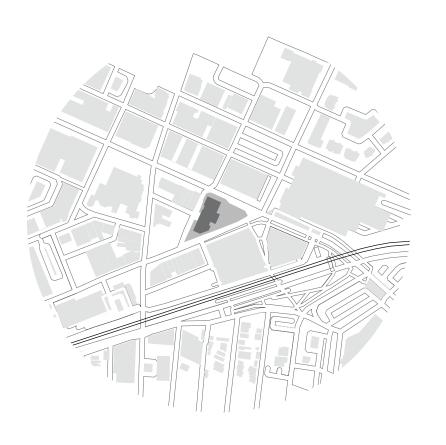
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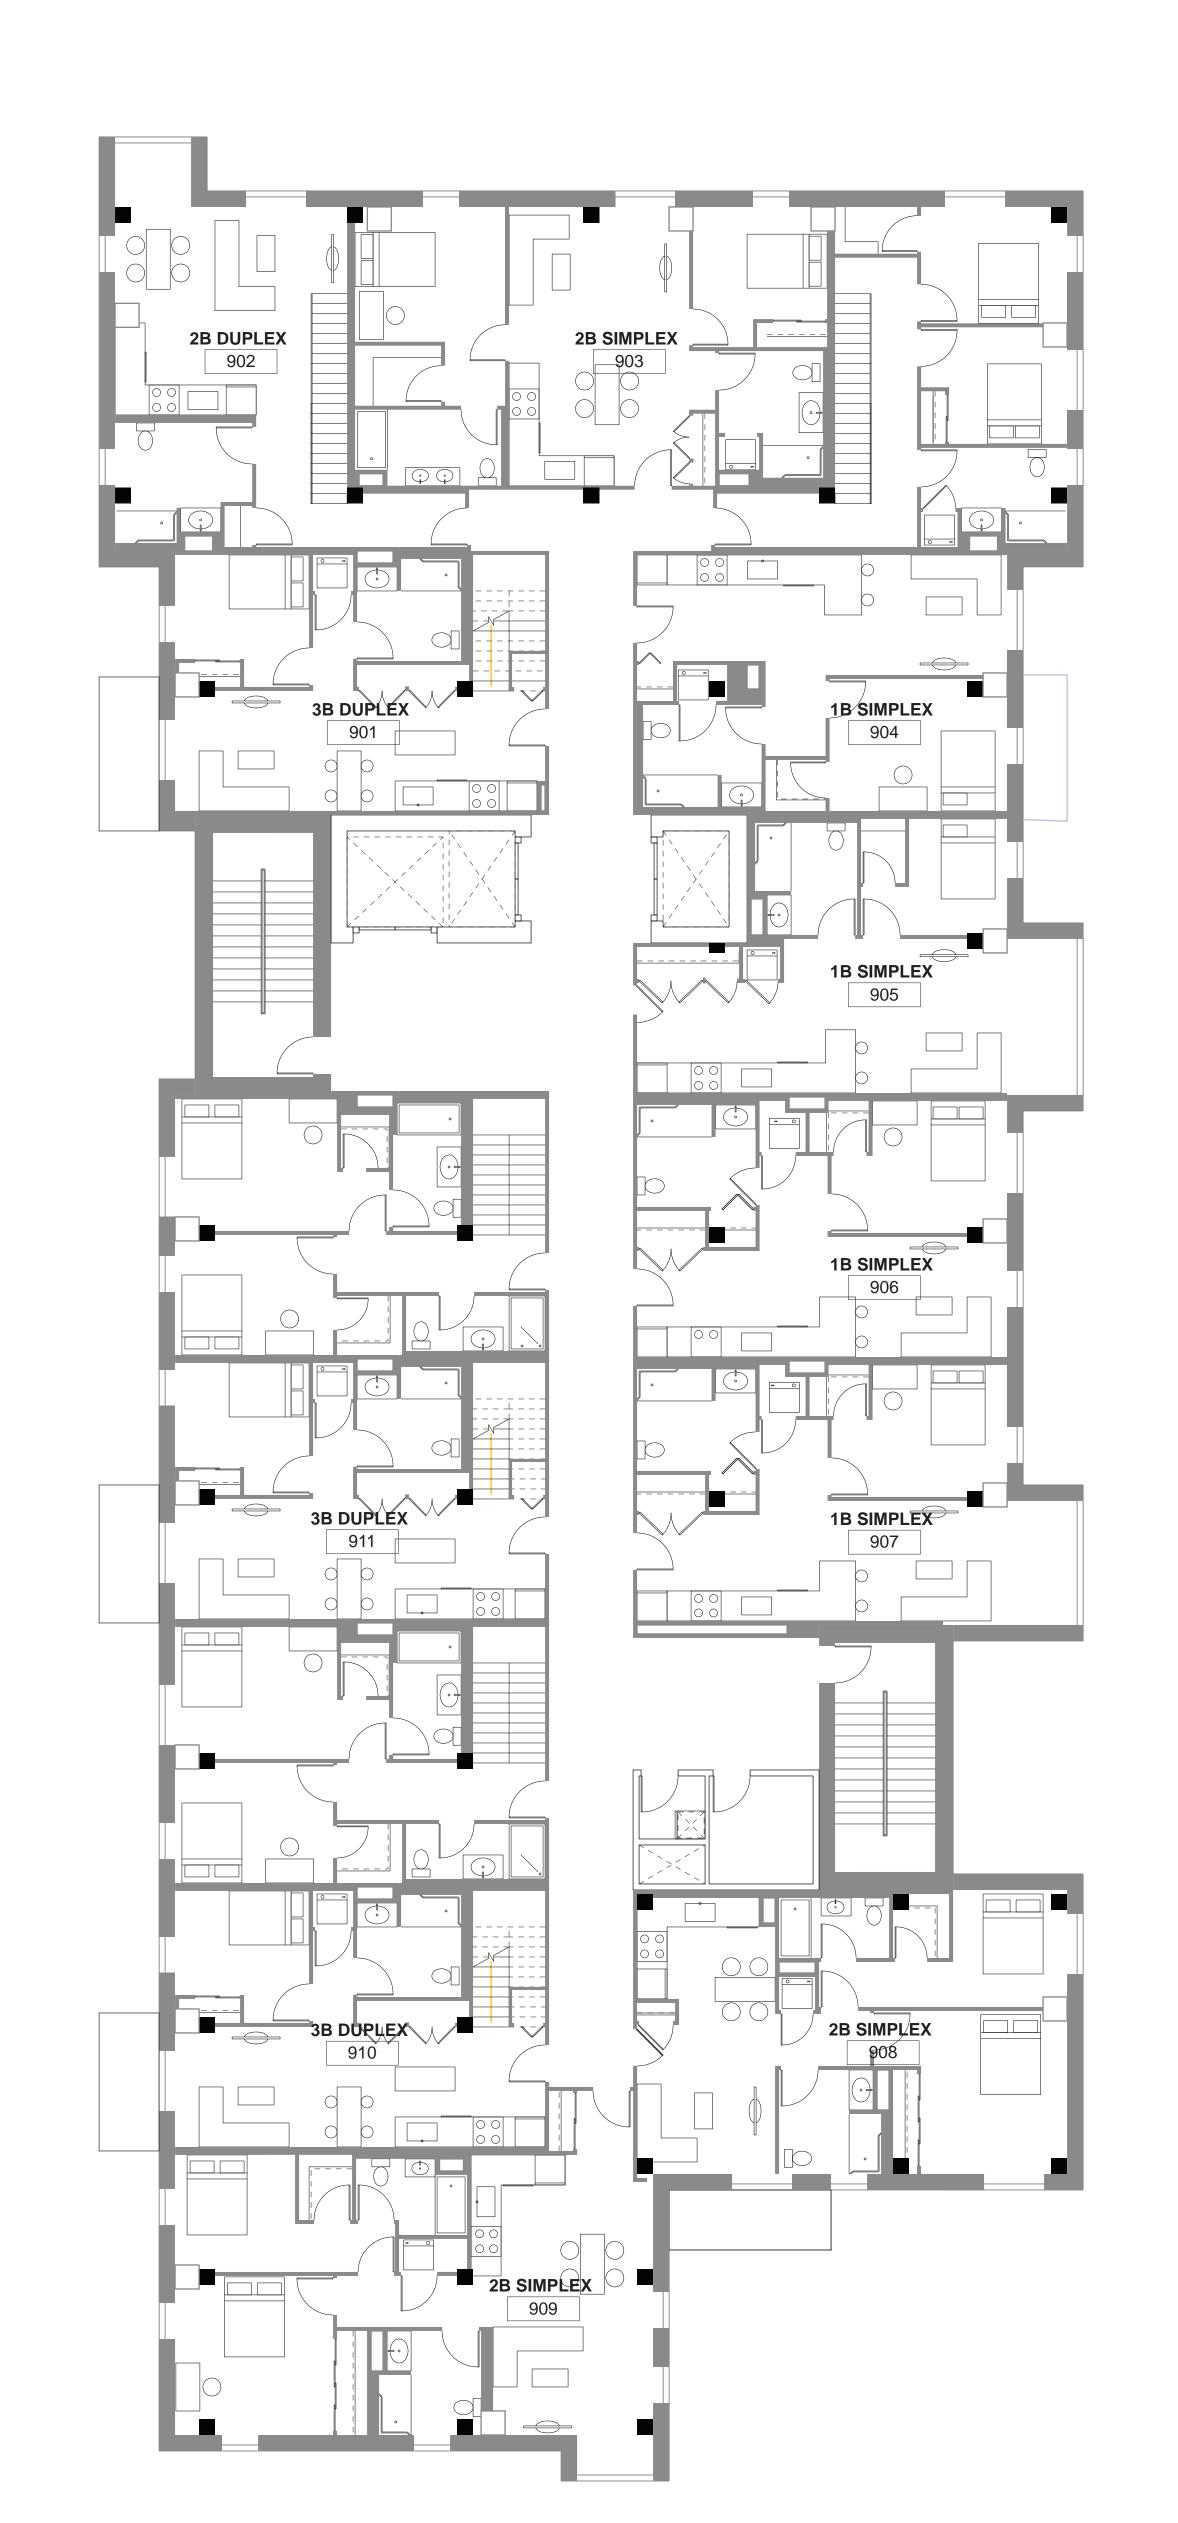
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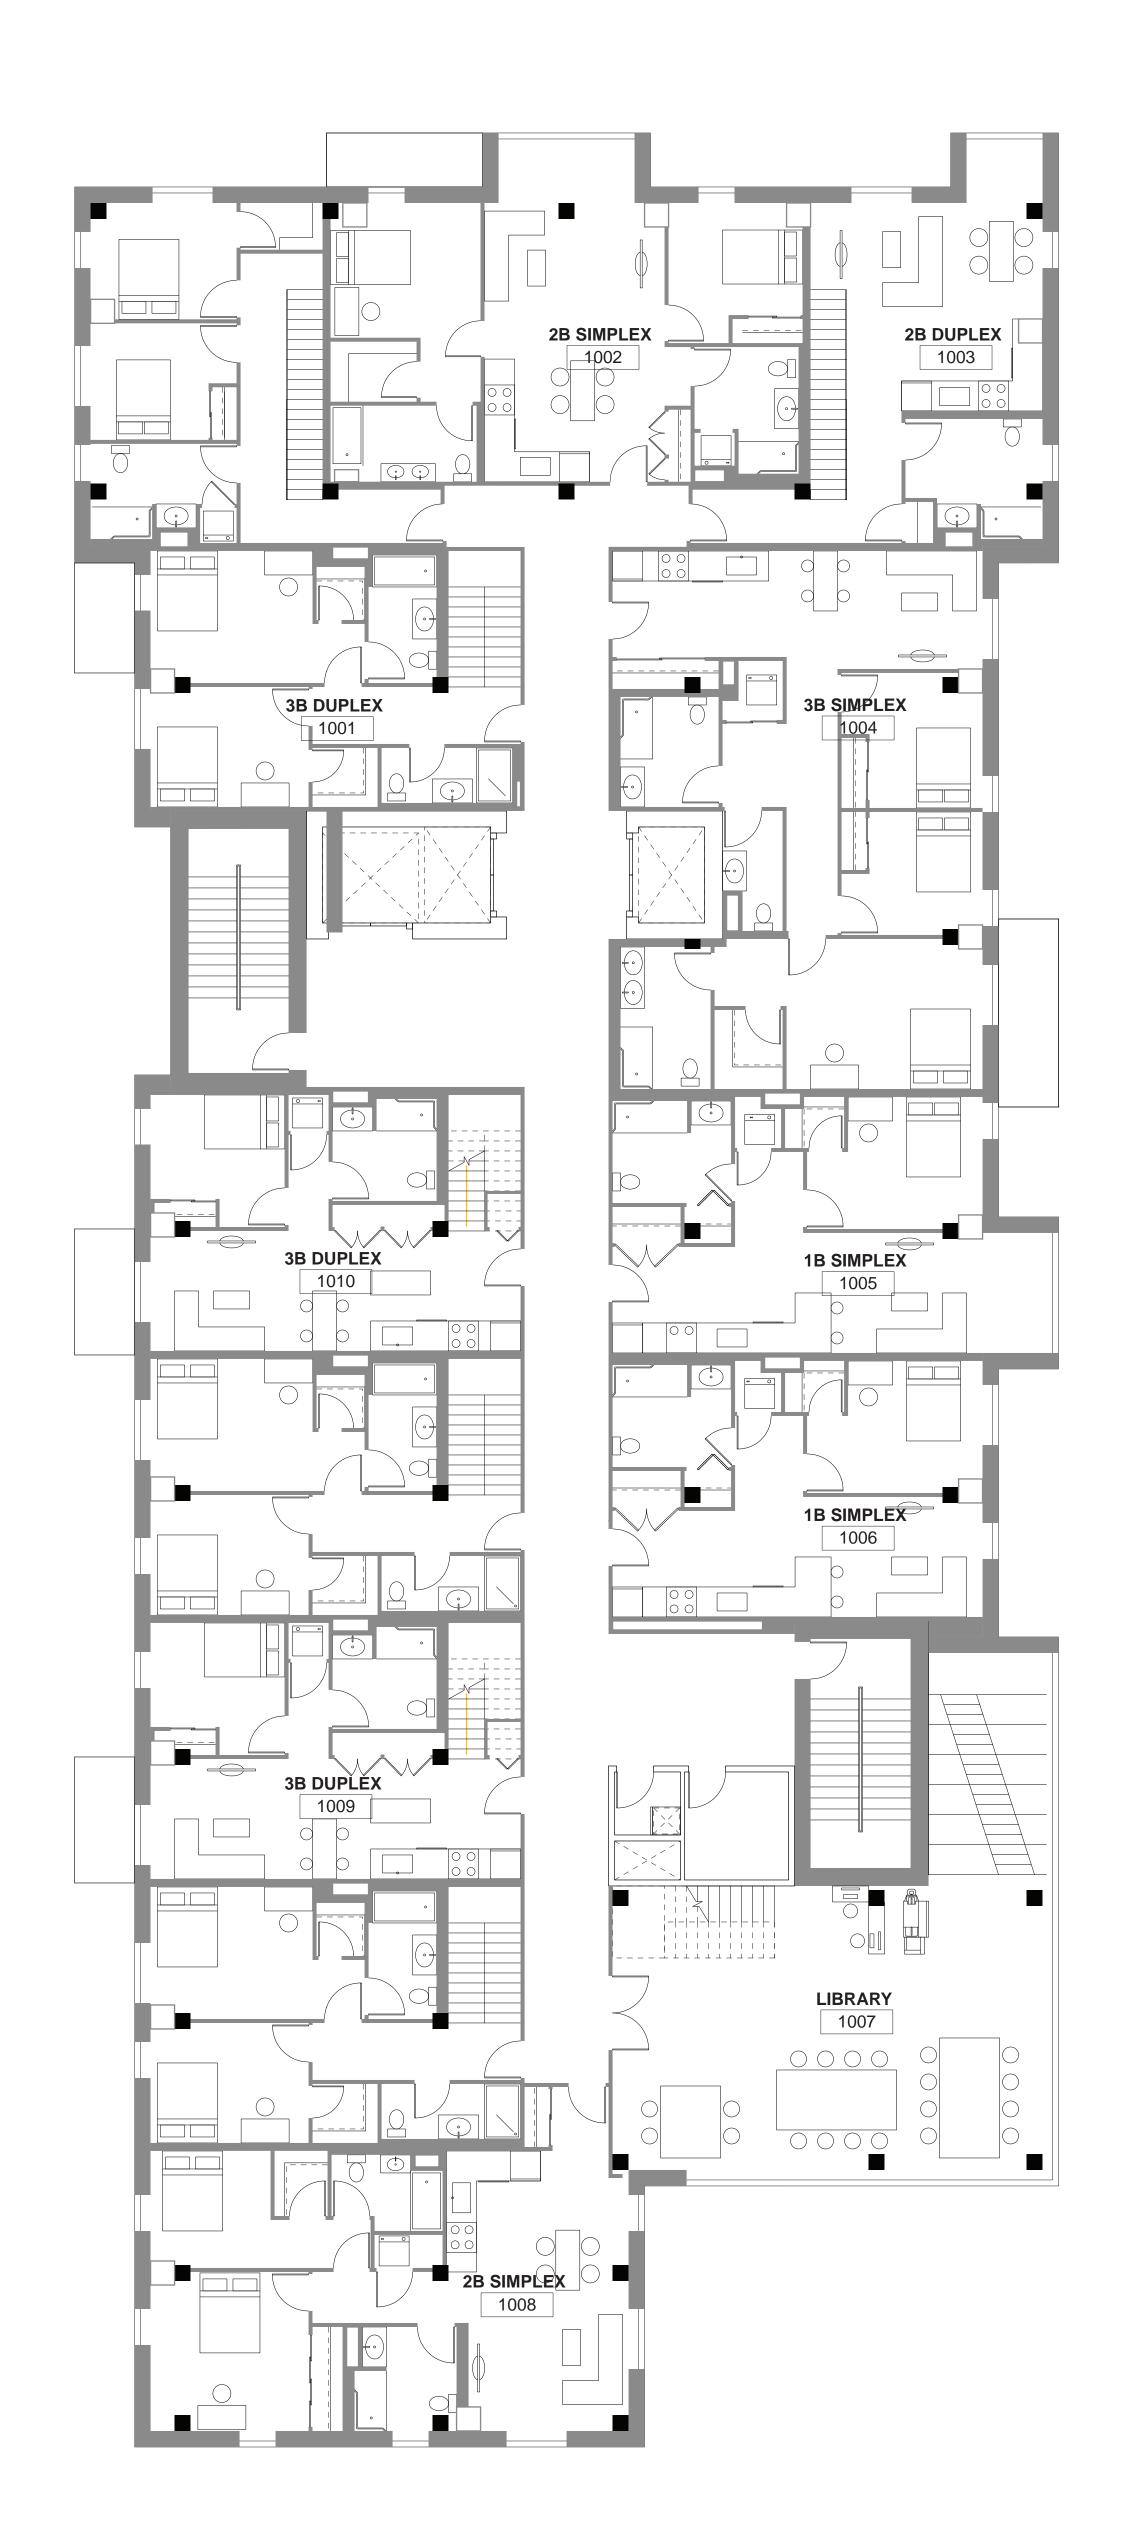
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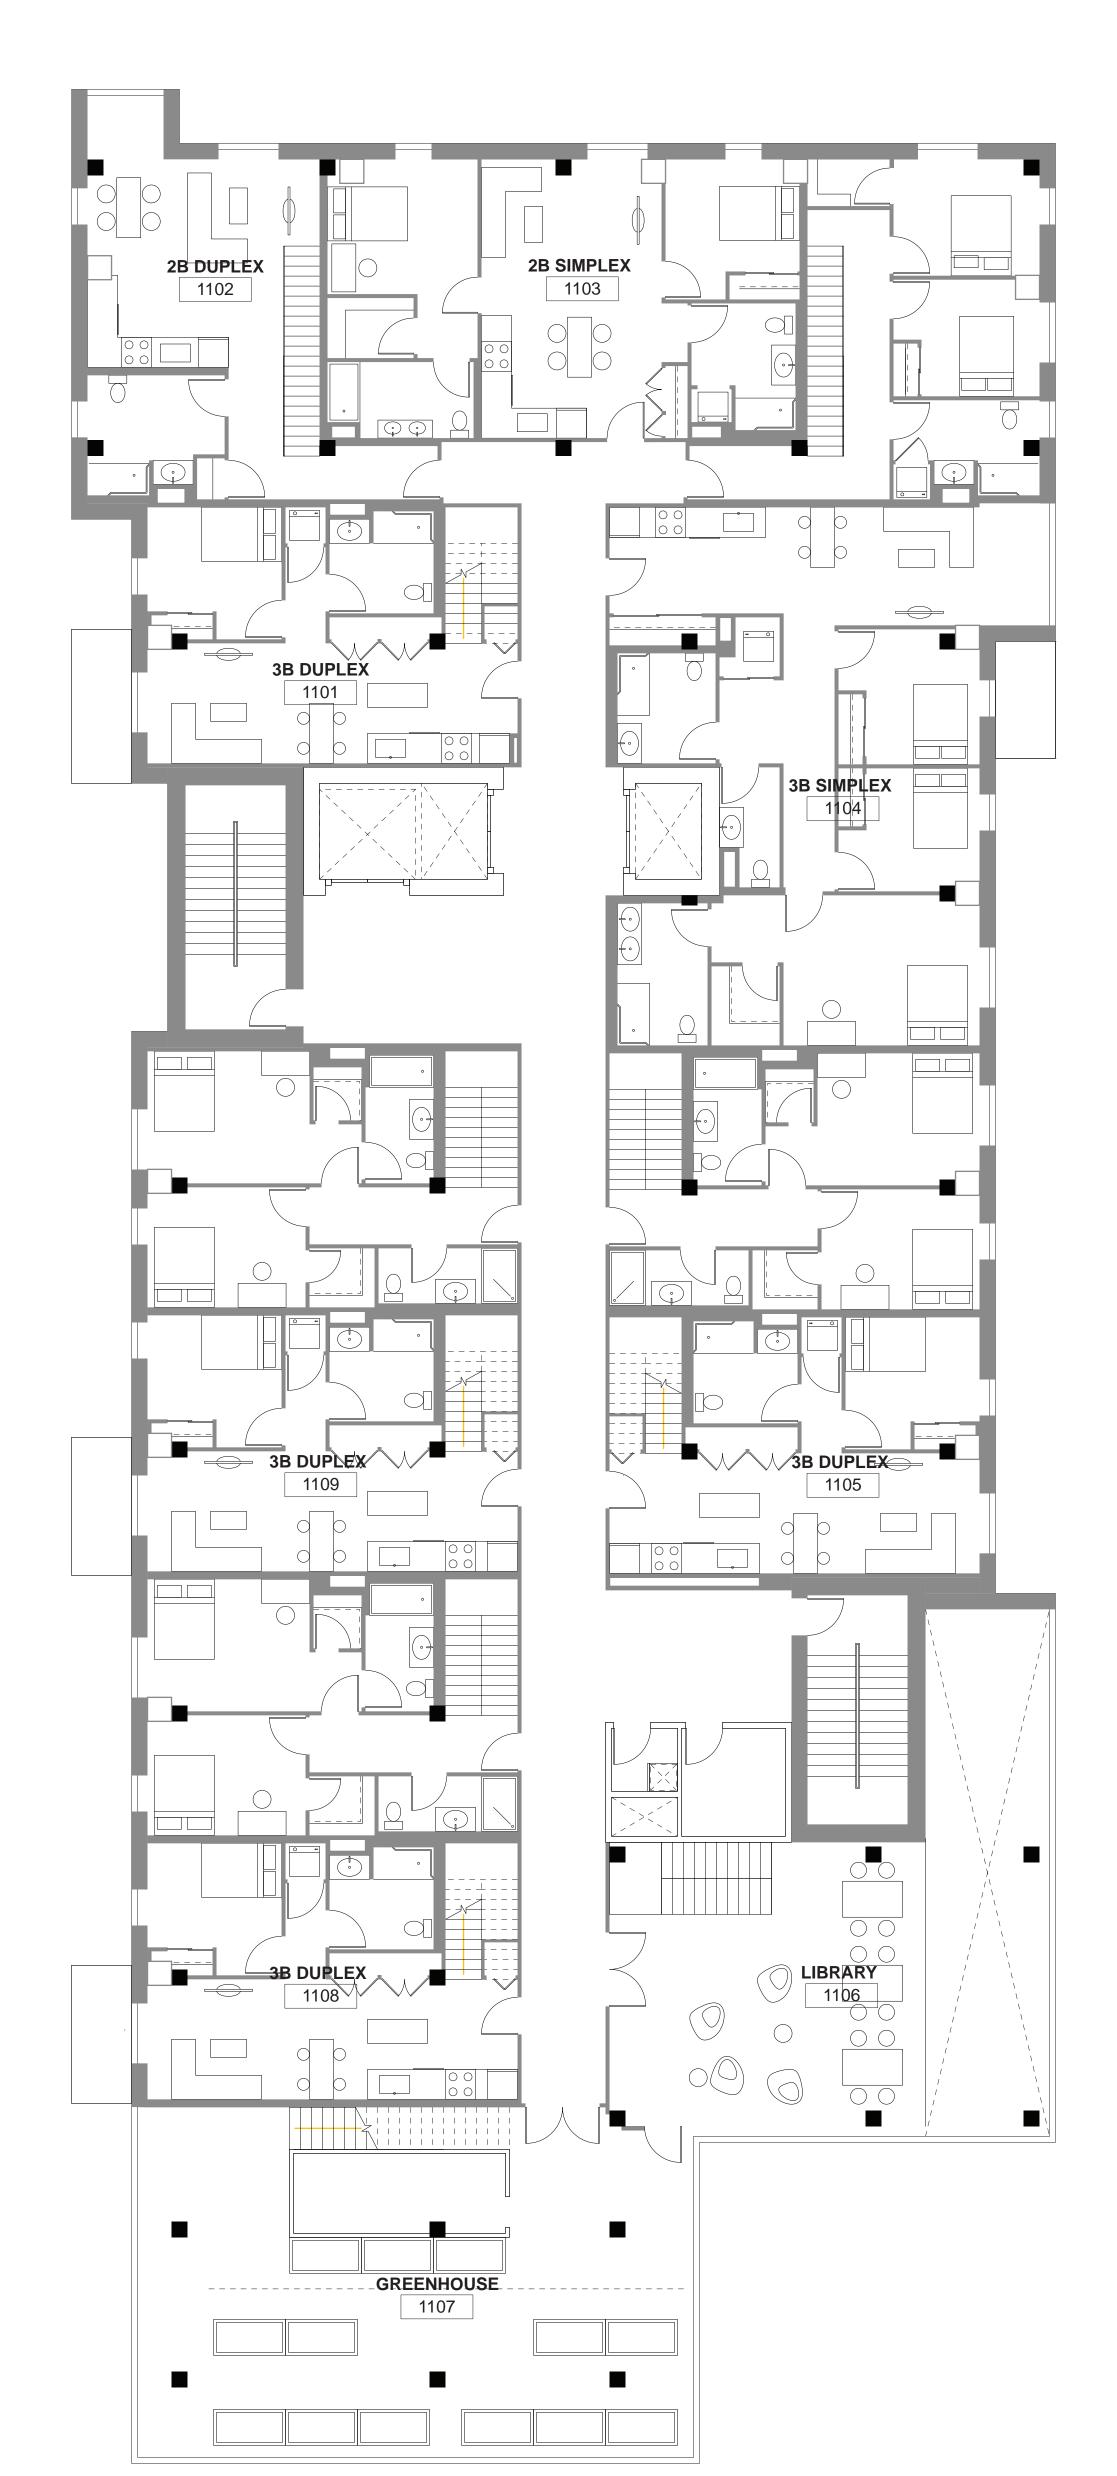
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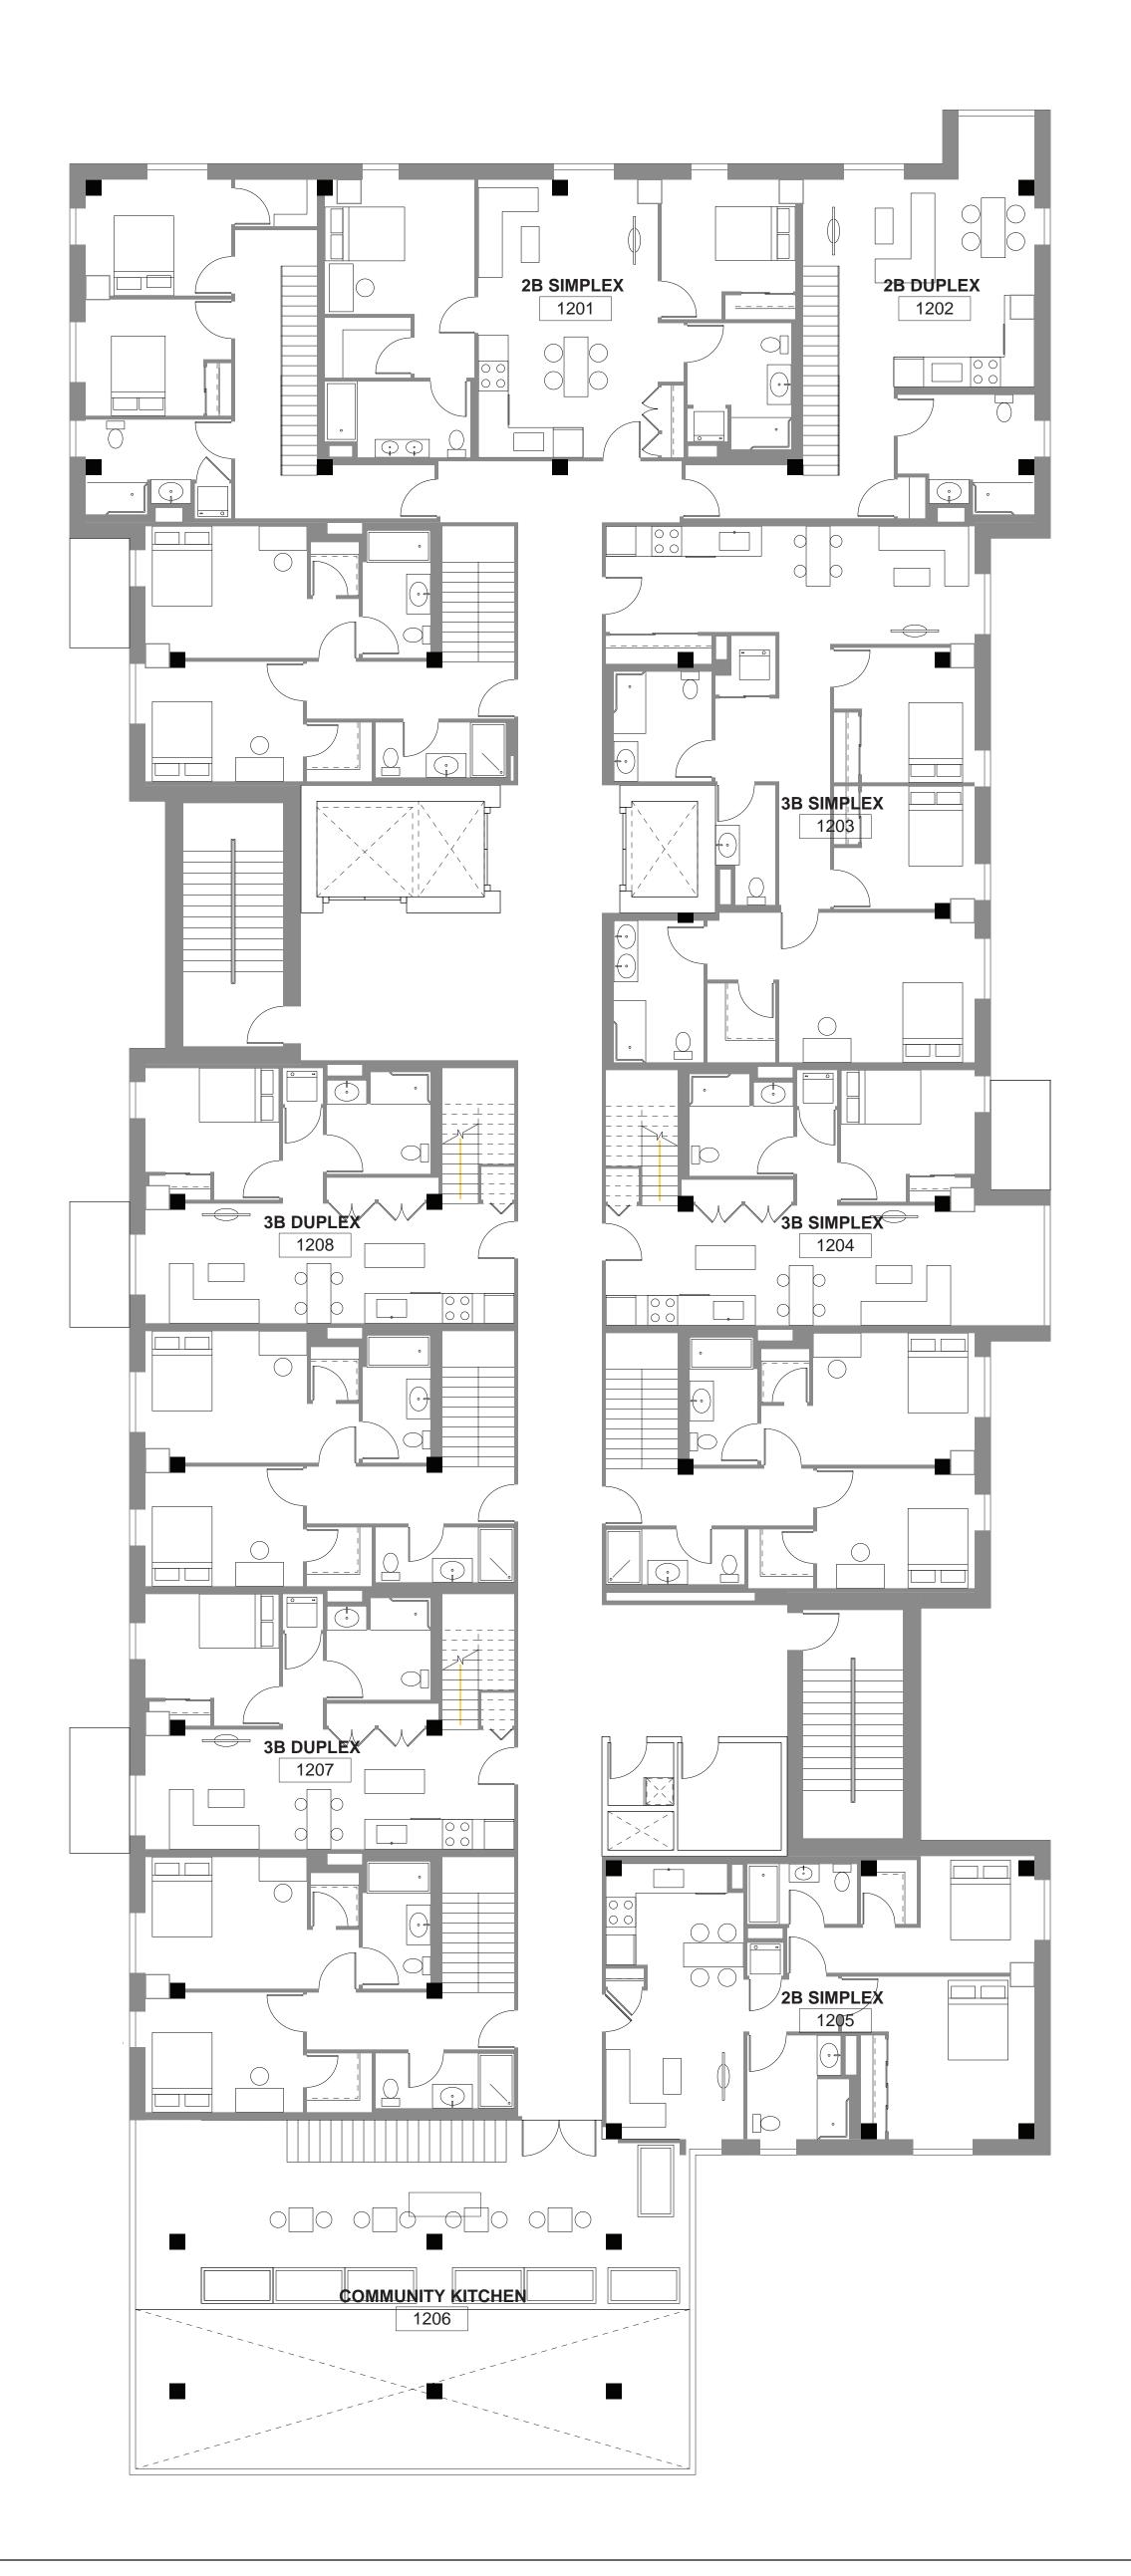
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Sheet Title: RESIDENTIAL FLOOR PLAN

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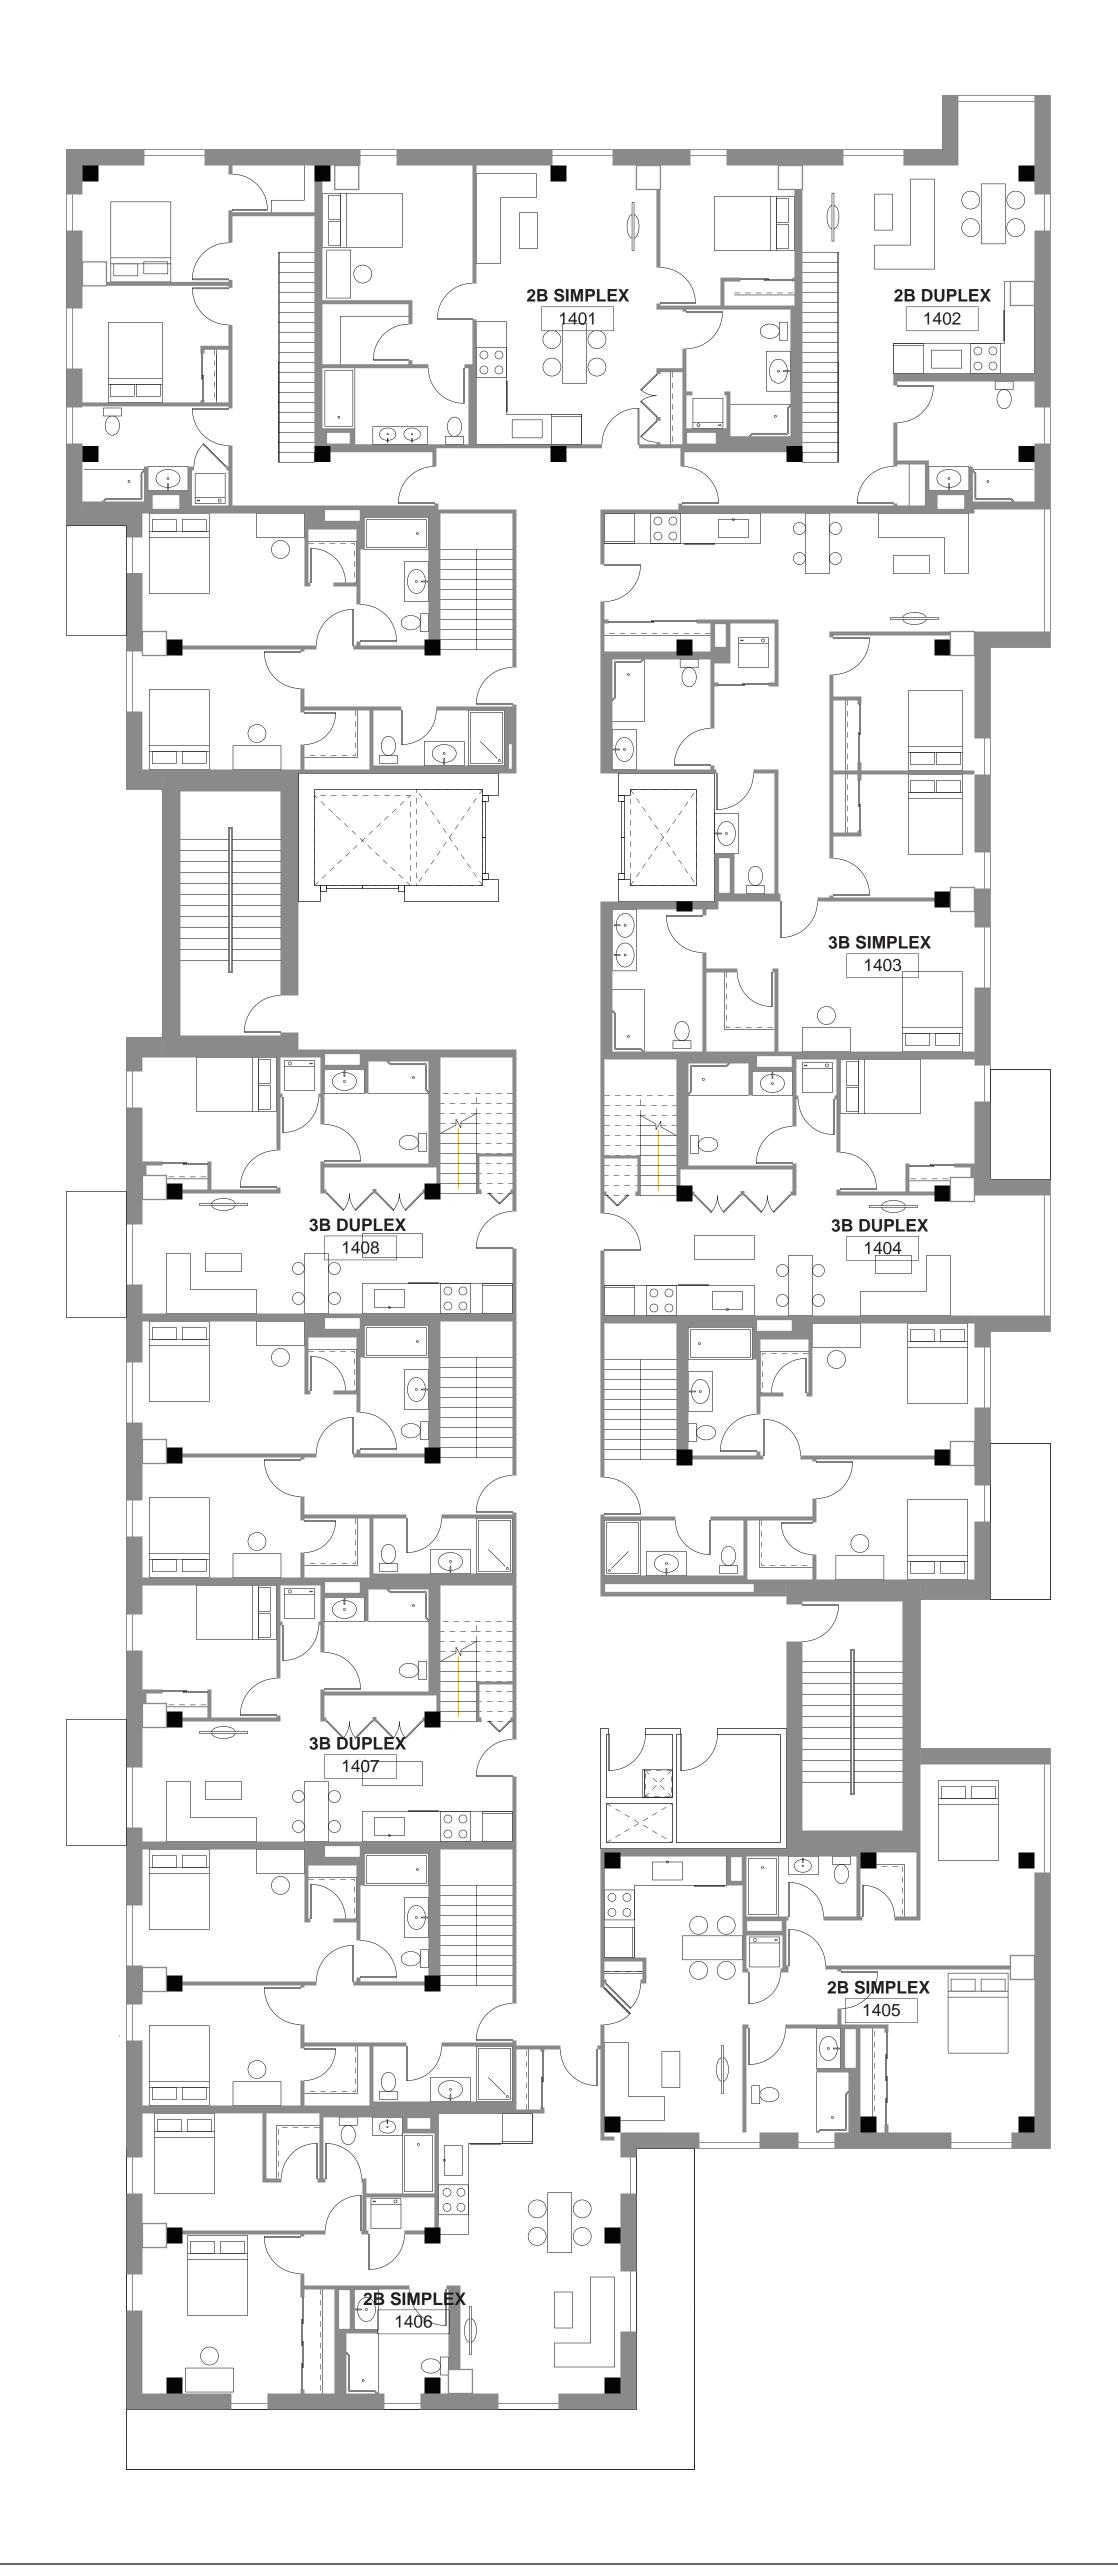
1 11TH FLOOR PLAN

SCALE: 1/8" = 1'-0"

2 12TH FLOOR PLAN

SCALE: 1/8" = 1'-0"





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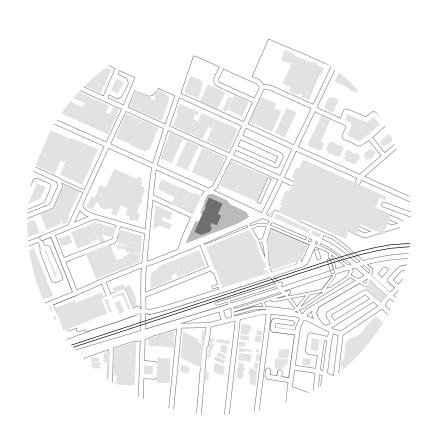
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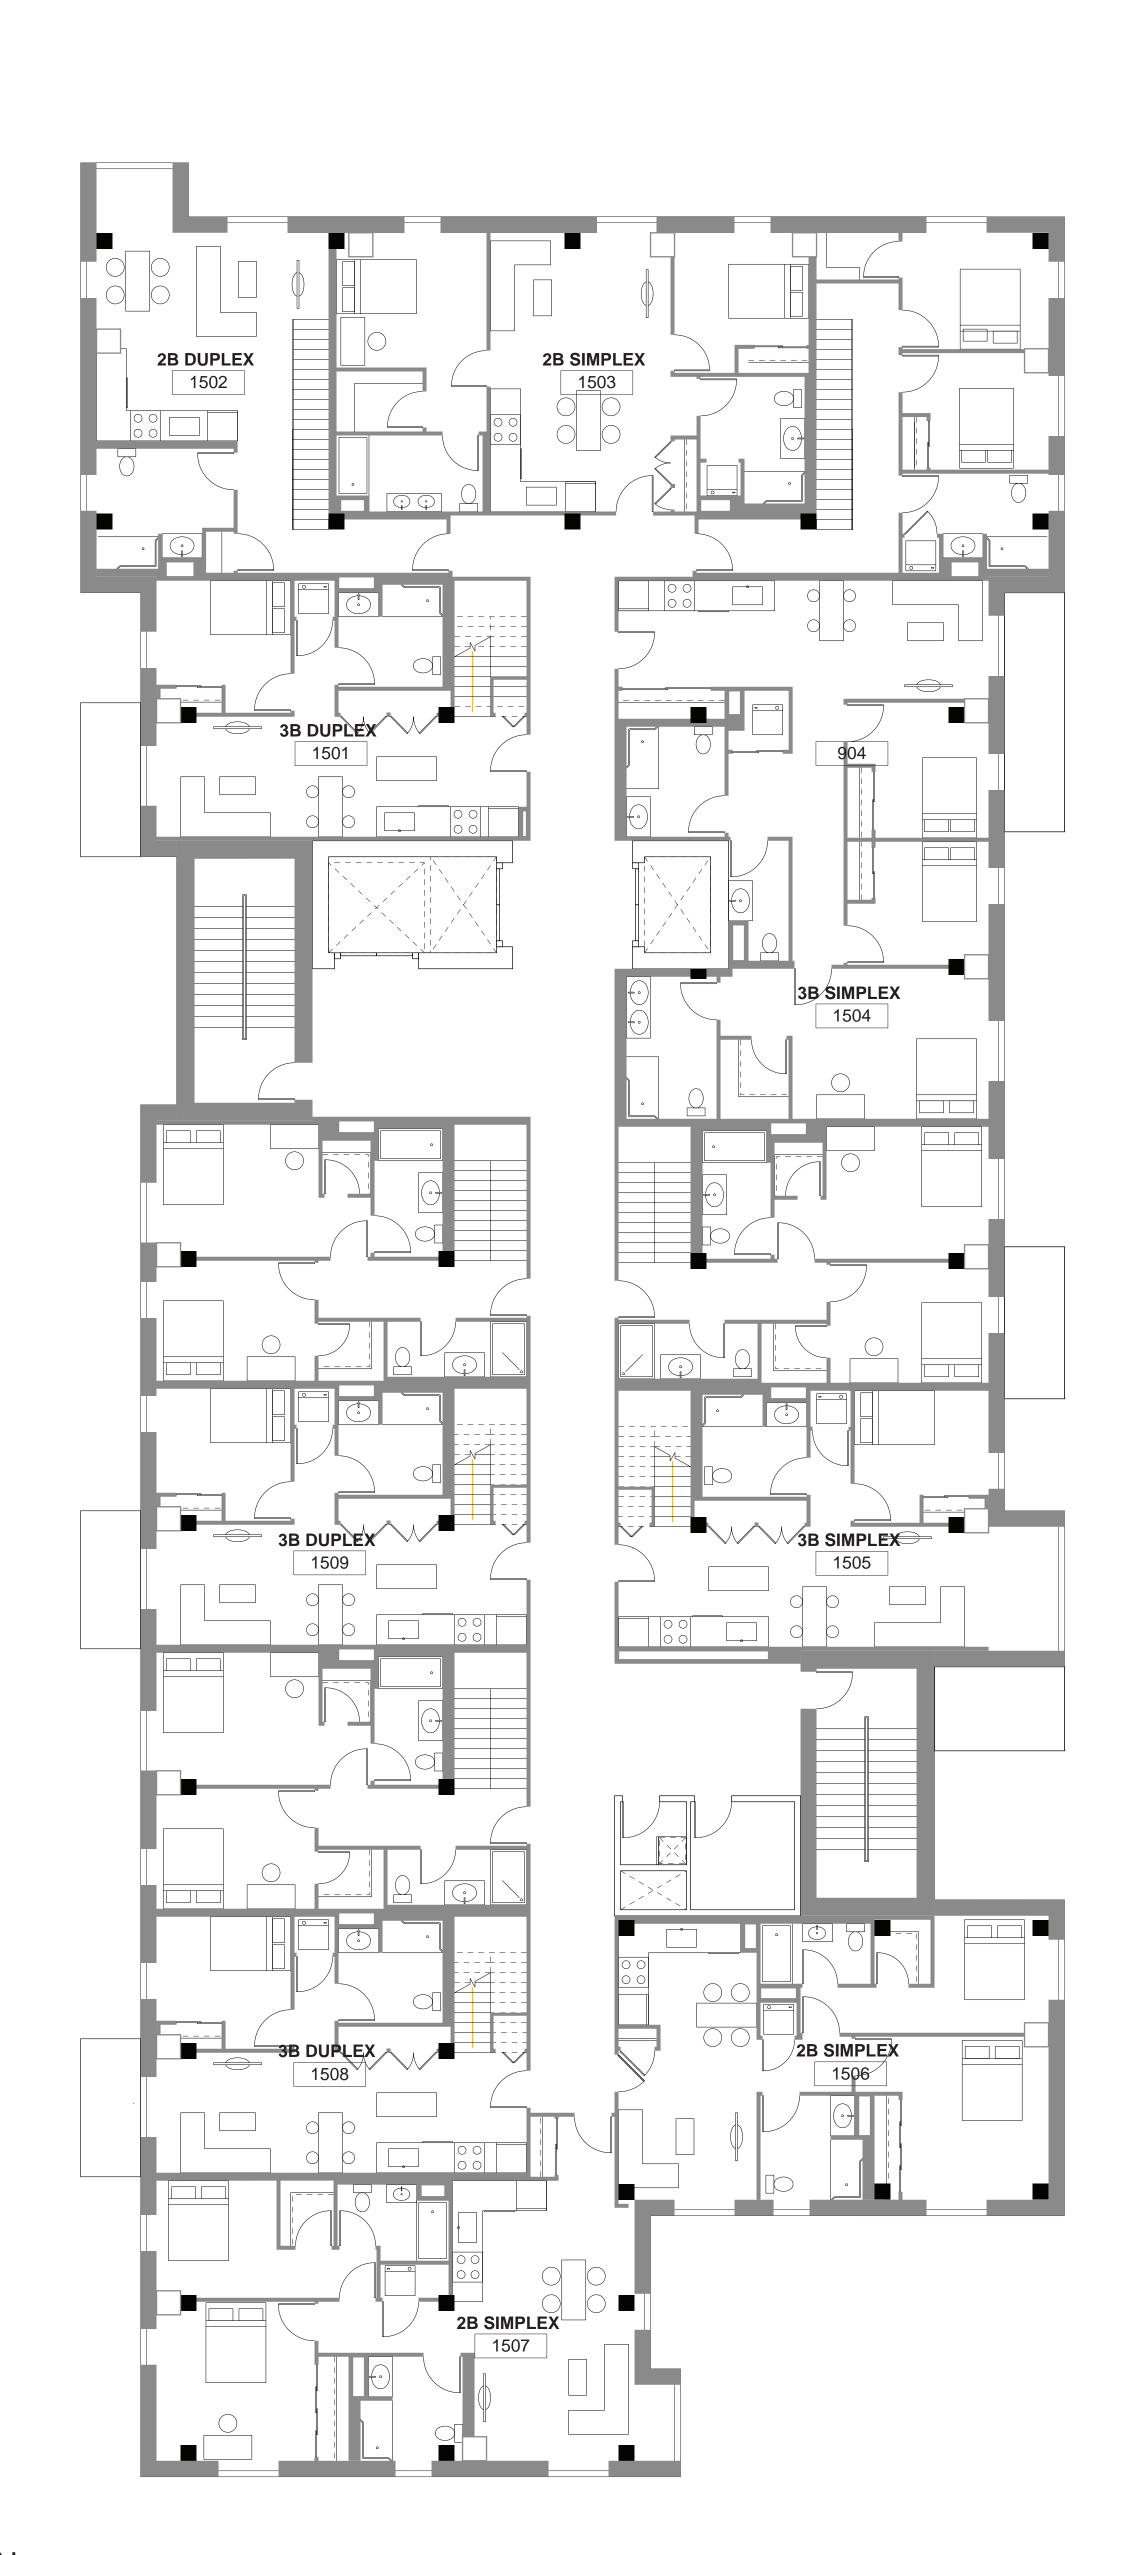
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1 13TH FLOOR PLAN

SCALE: 1/8" = 1'-0"

2 14TH FLOOR PLAN

SCALE: 1/8" = 1'-0"





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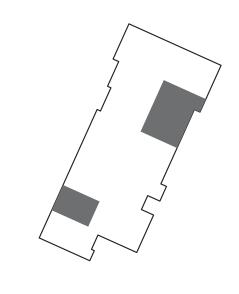
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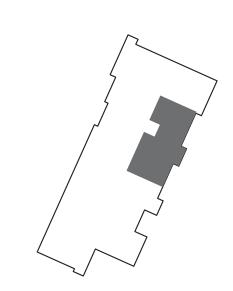
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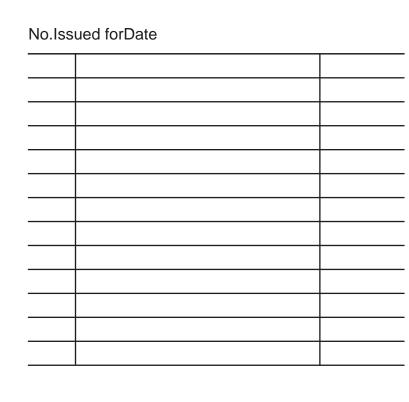
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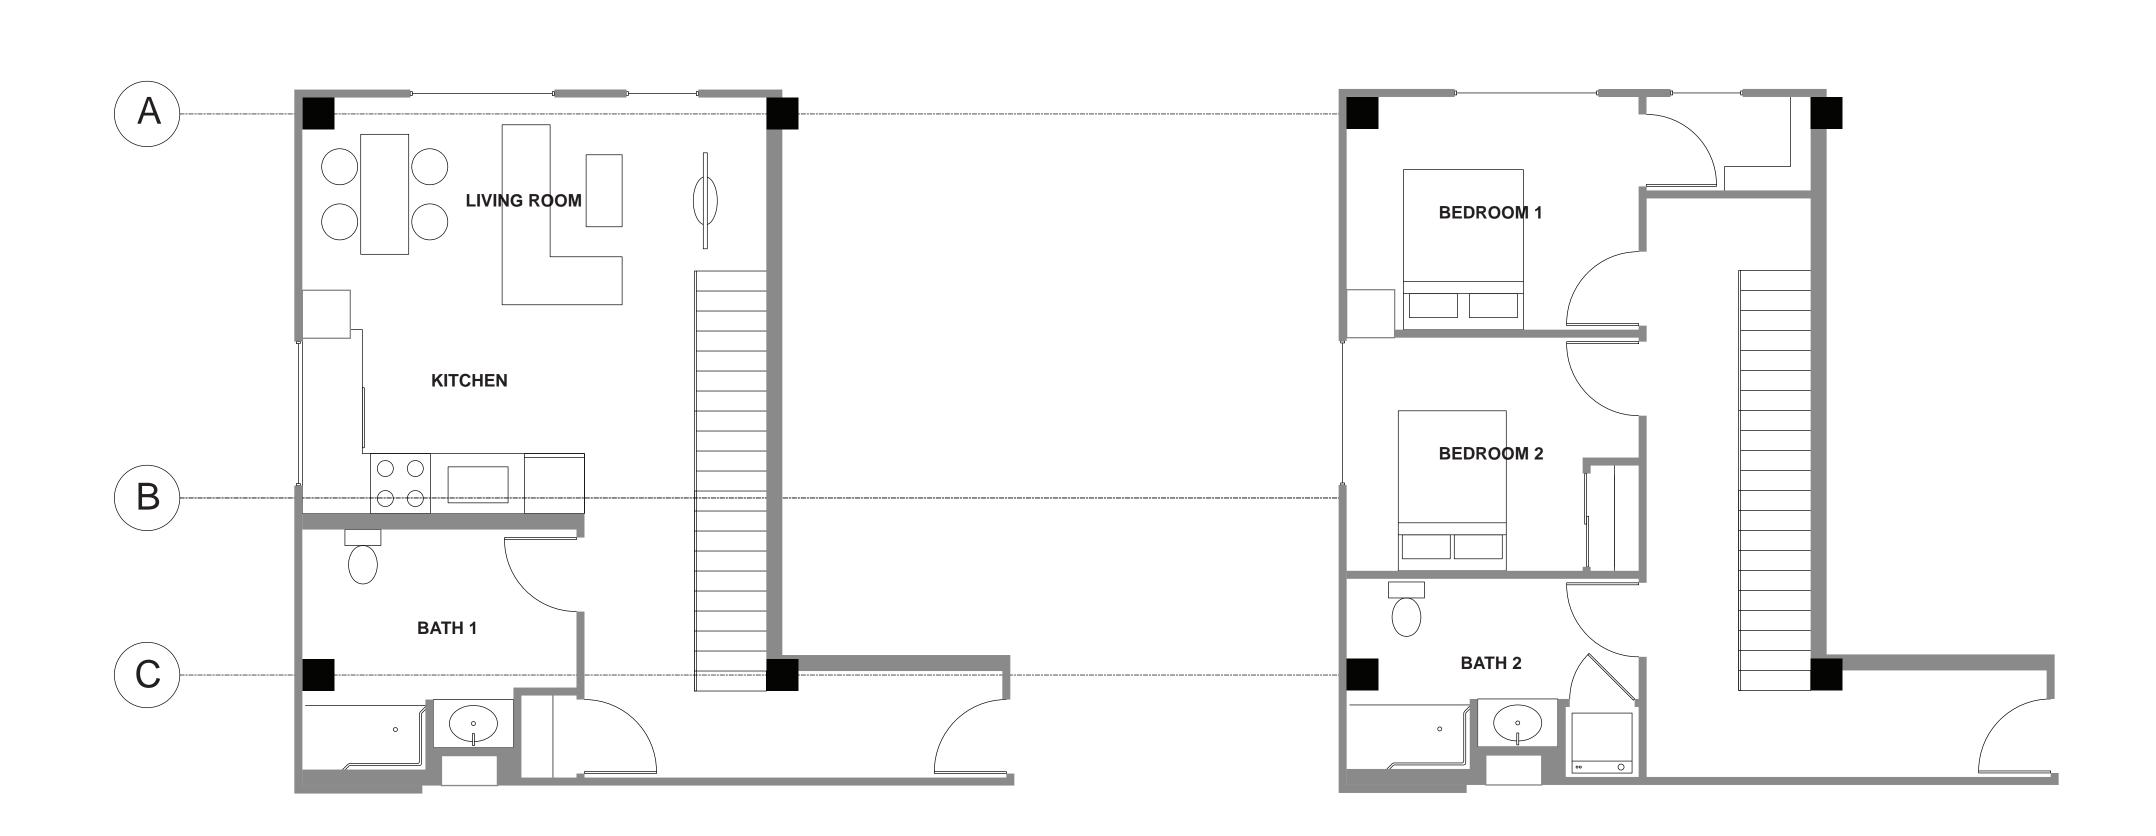
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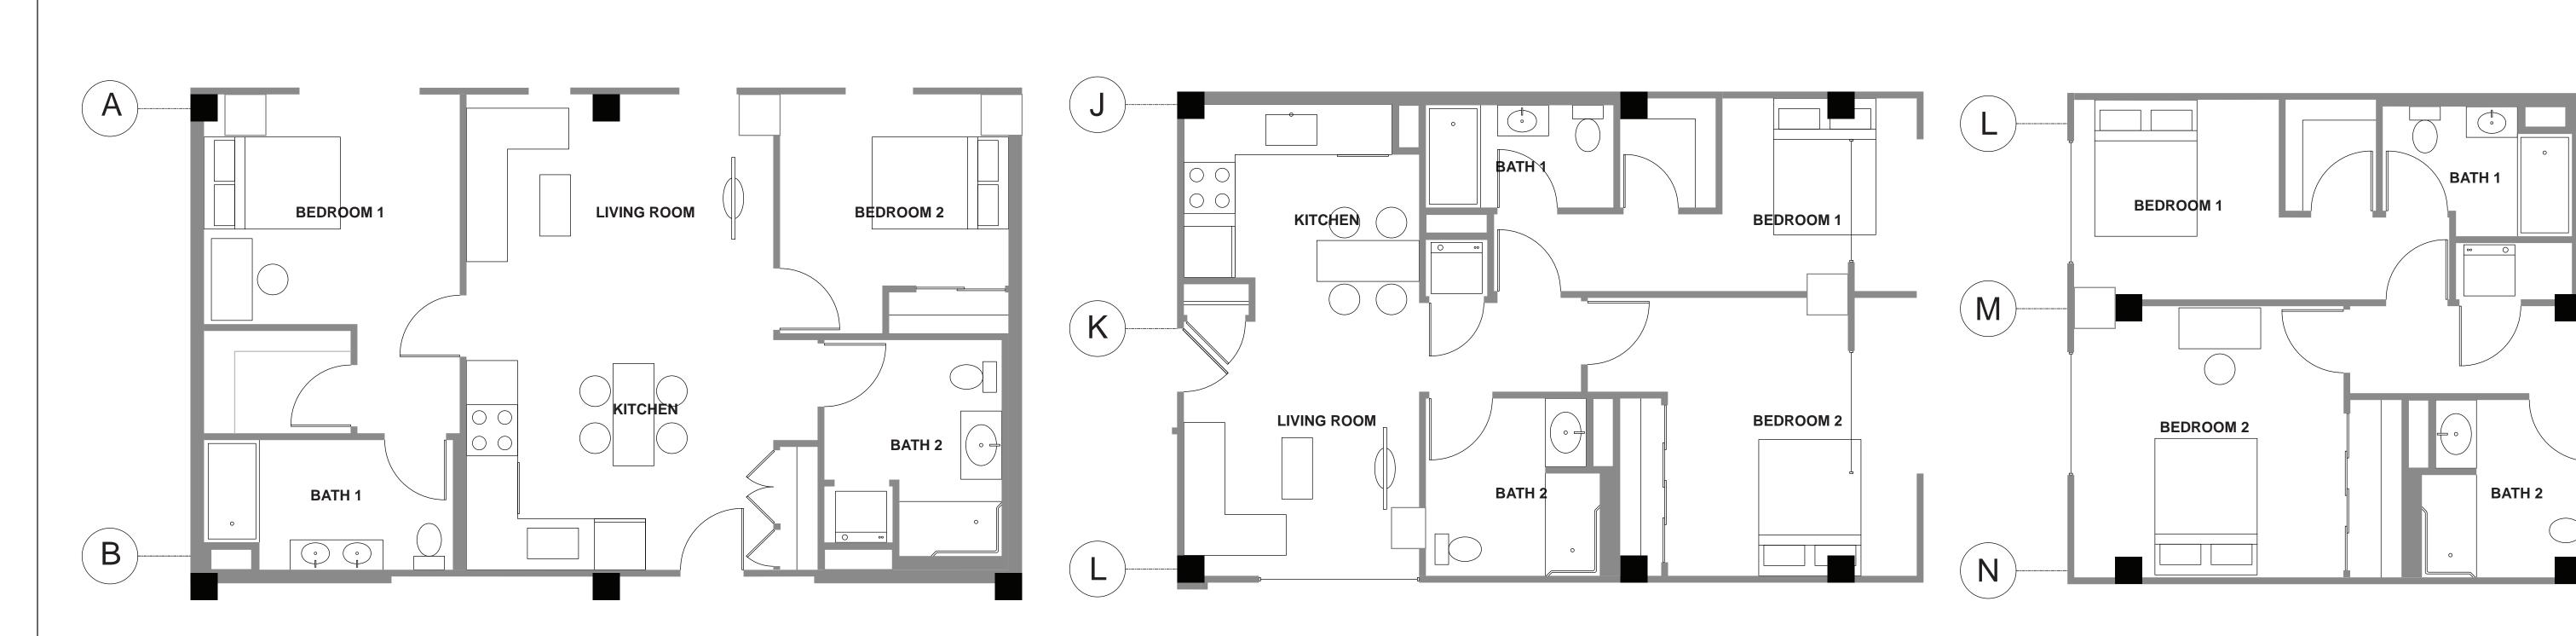
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Sheet Title: ENLARGED UNIT PLANS





3 2B SIMPLEX TYPE A (UNIT 401)

SCALE: 1/4" = 1'-0"

4 2B SIMPLEX TYPE B (UNIT 405)

SCALE: 1/4" = 1'-0"

2B DUPLEX 1ST FLOOR (UNIT 302)
SCALE: 1/4" = 1'-0"

5 2B SIMPLEX TYPE C (UNIT 406)

SCALE: 1/4" = 1'-0"

2B DUPLEX 2ND FLOOR (UNIT 302)
SCALE: 1/4" = 1'-0"

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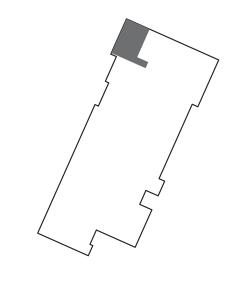
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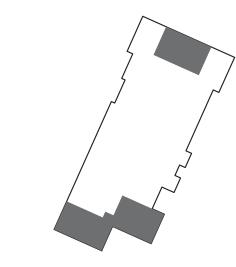
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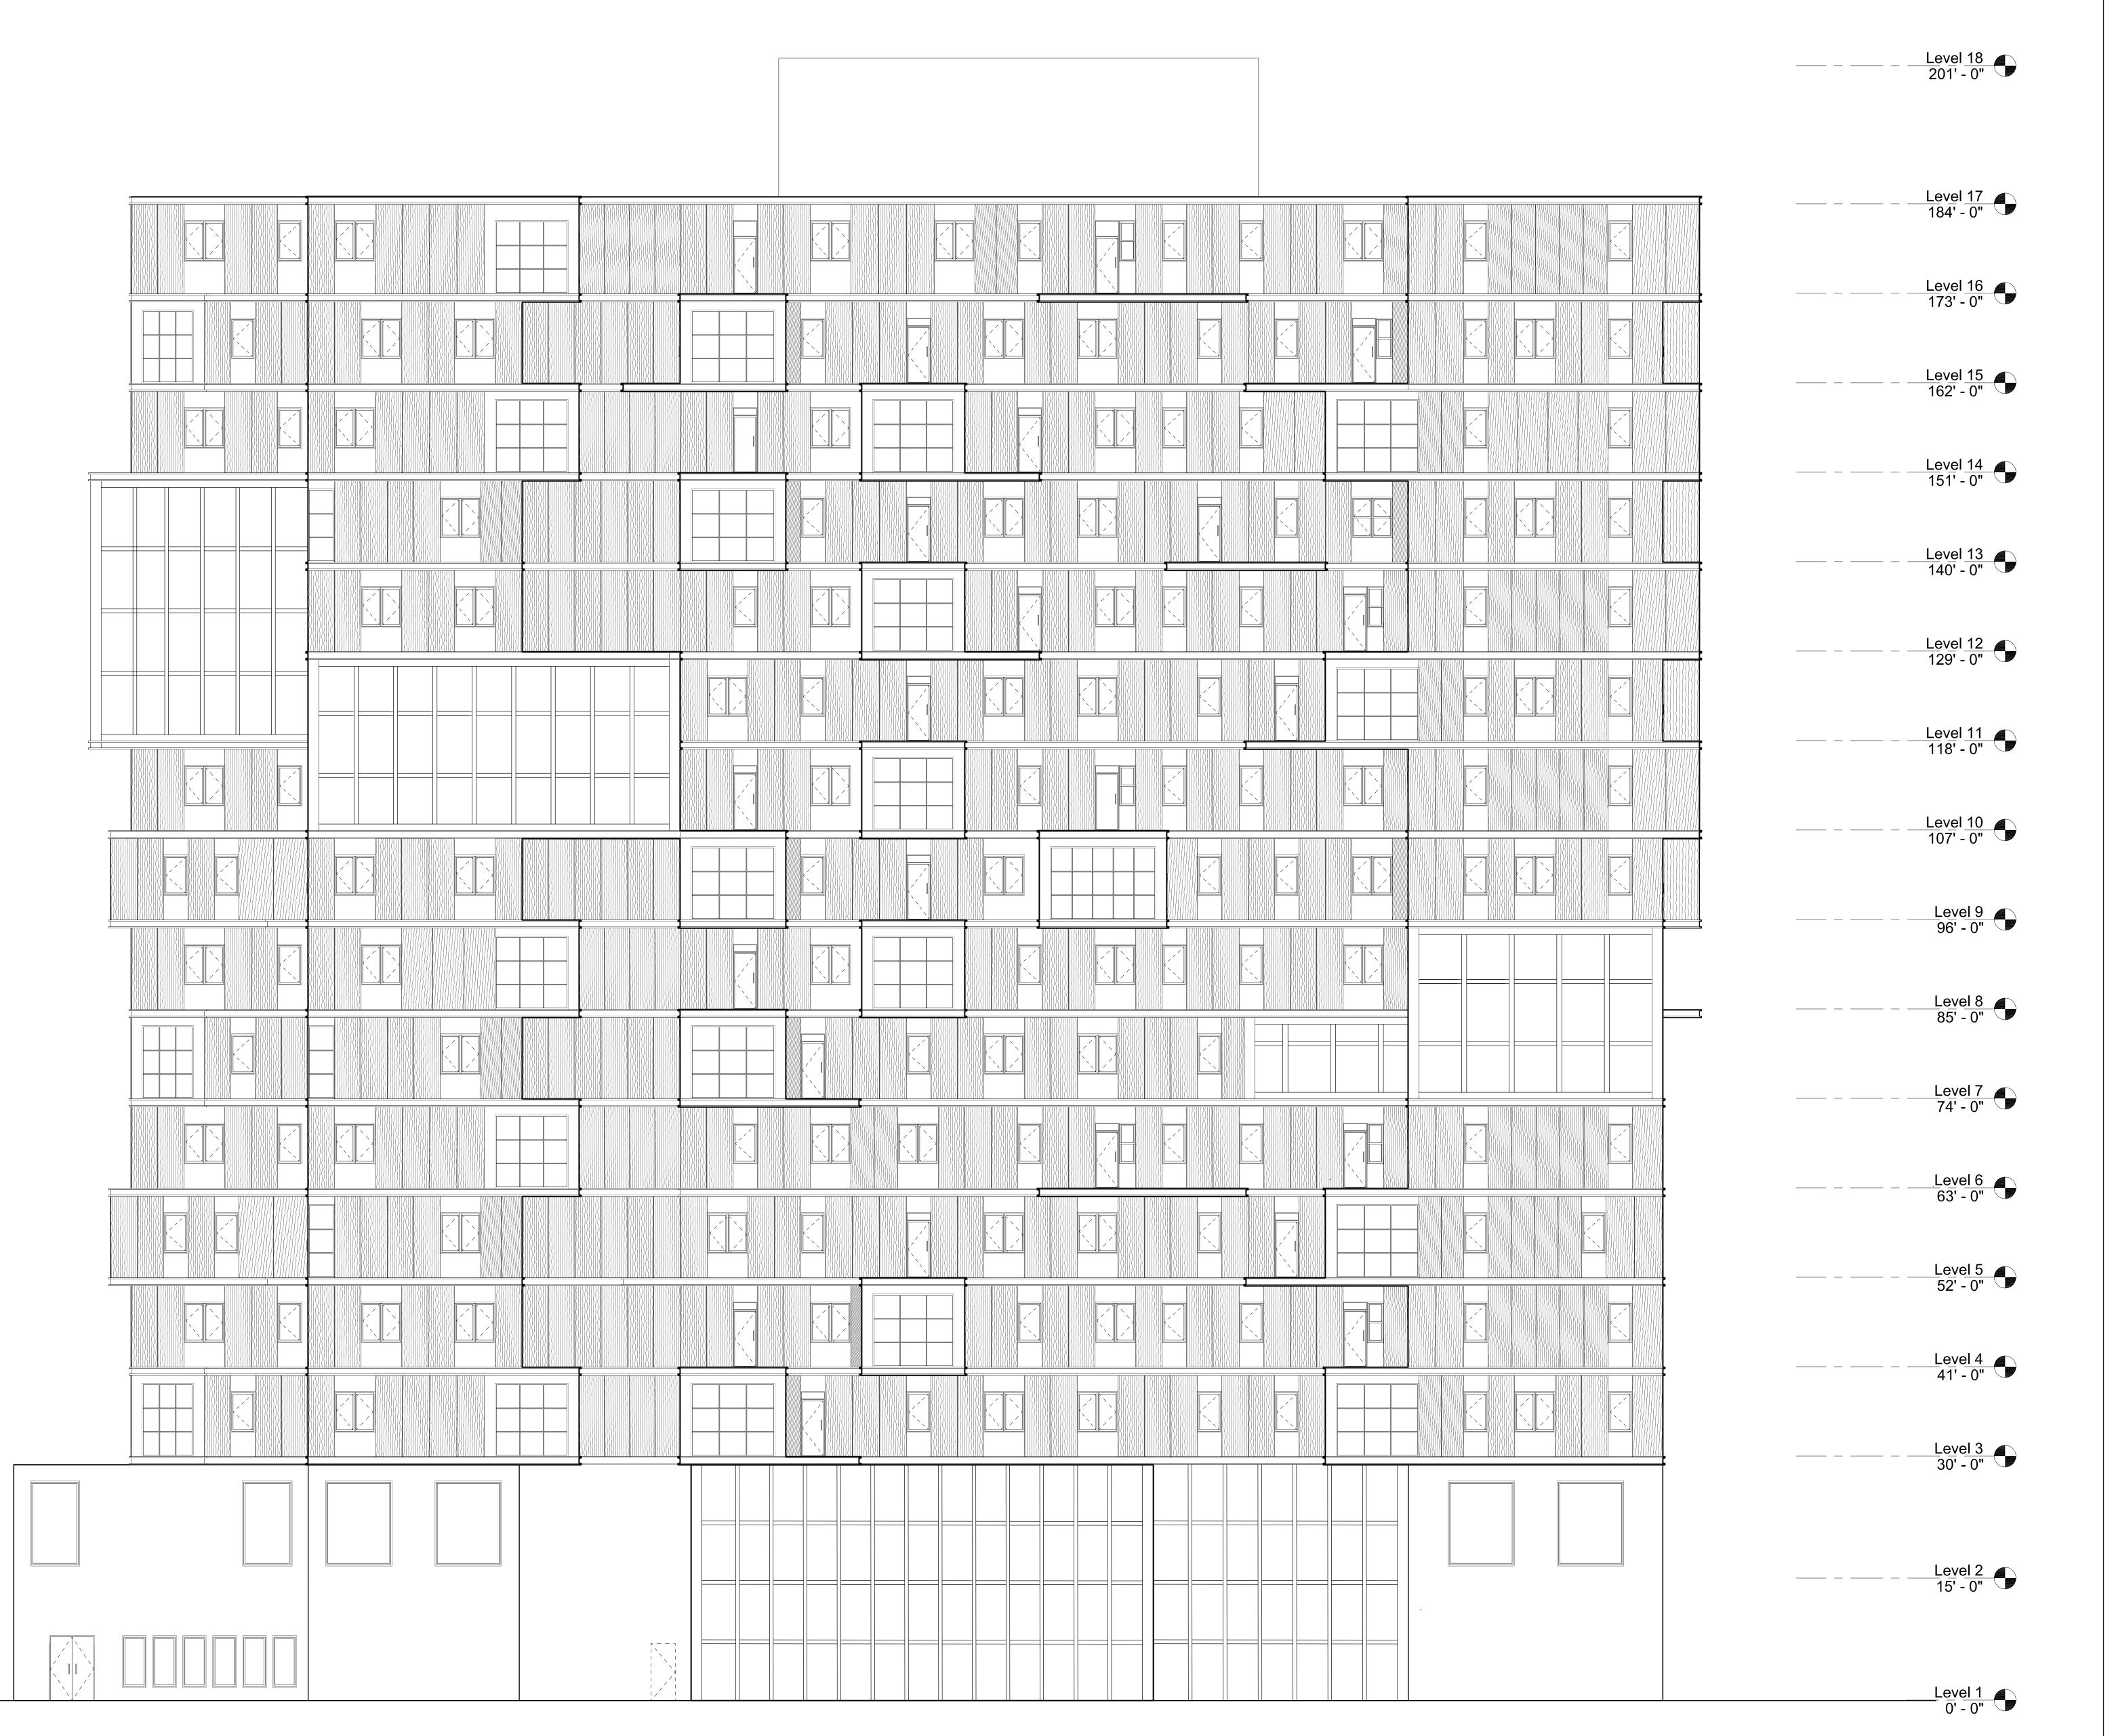
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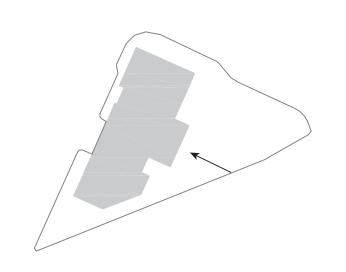
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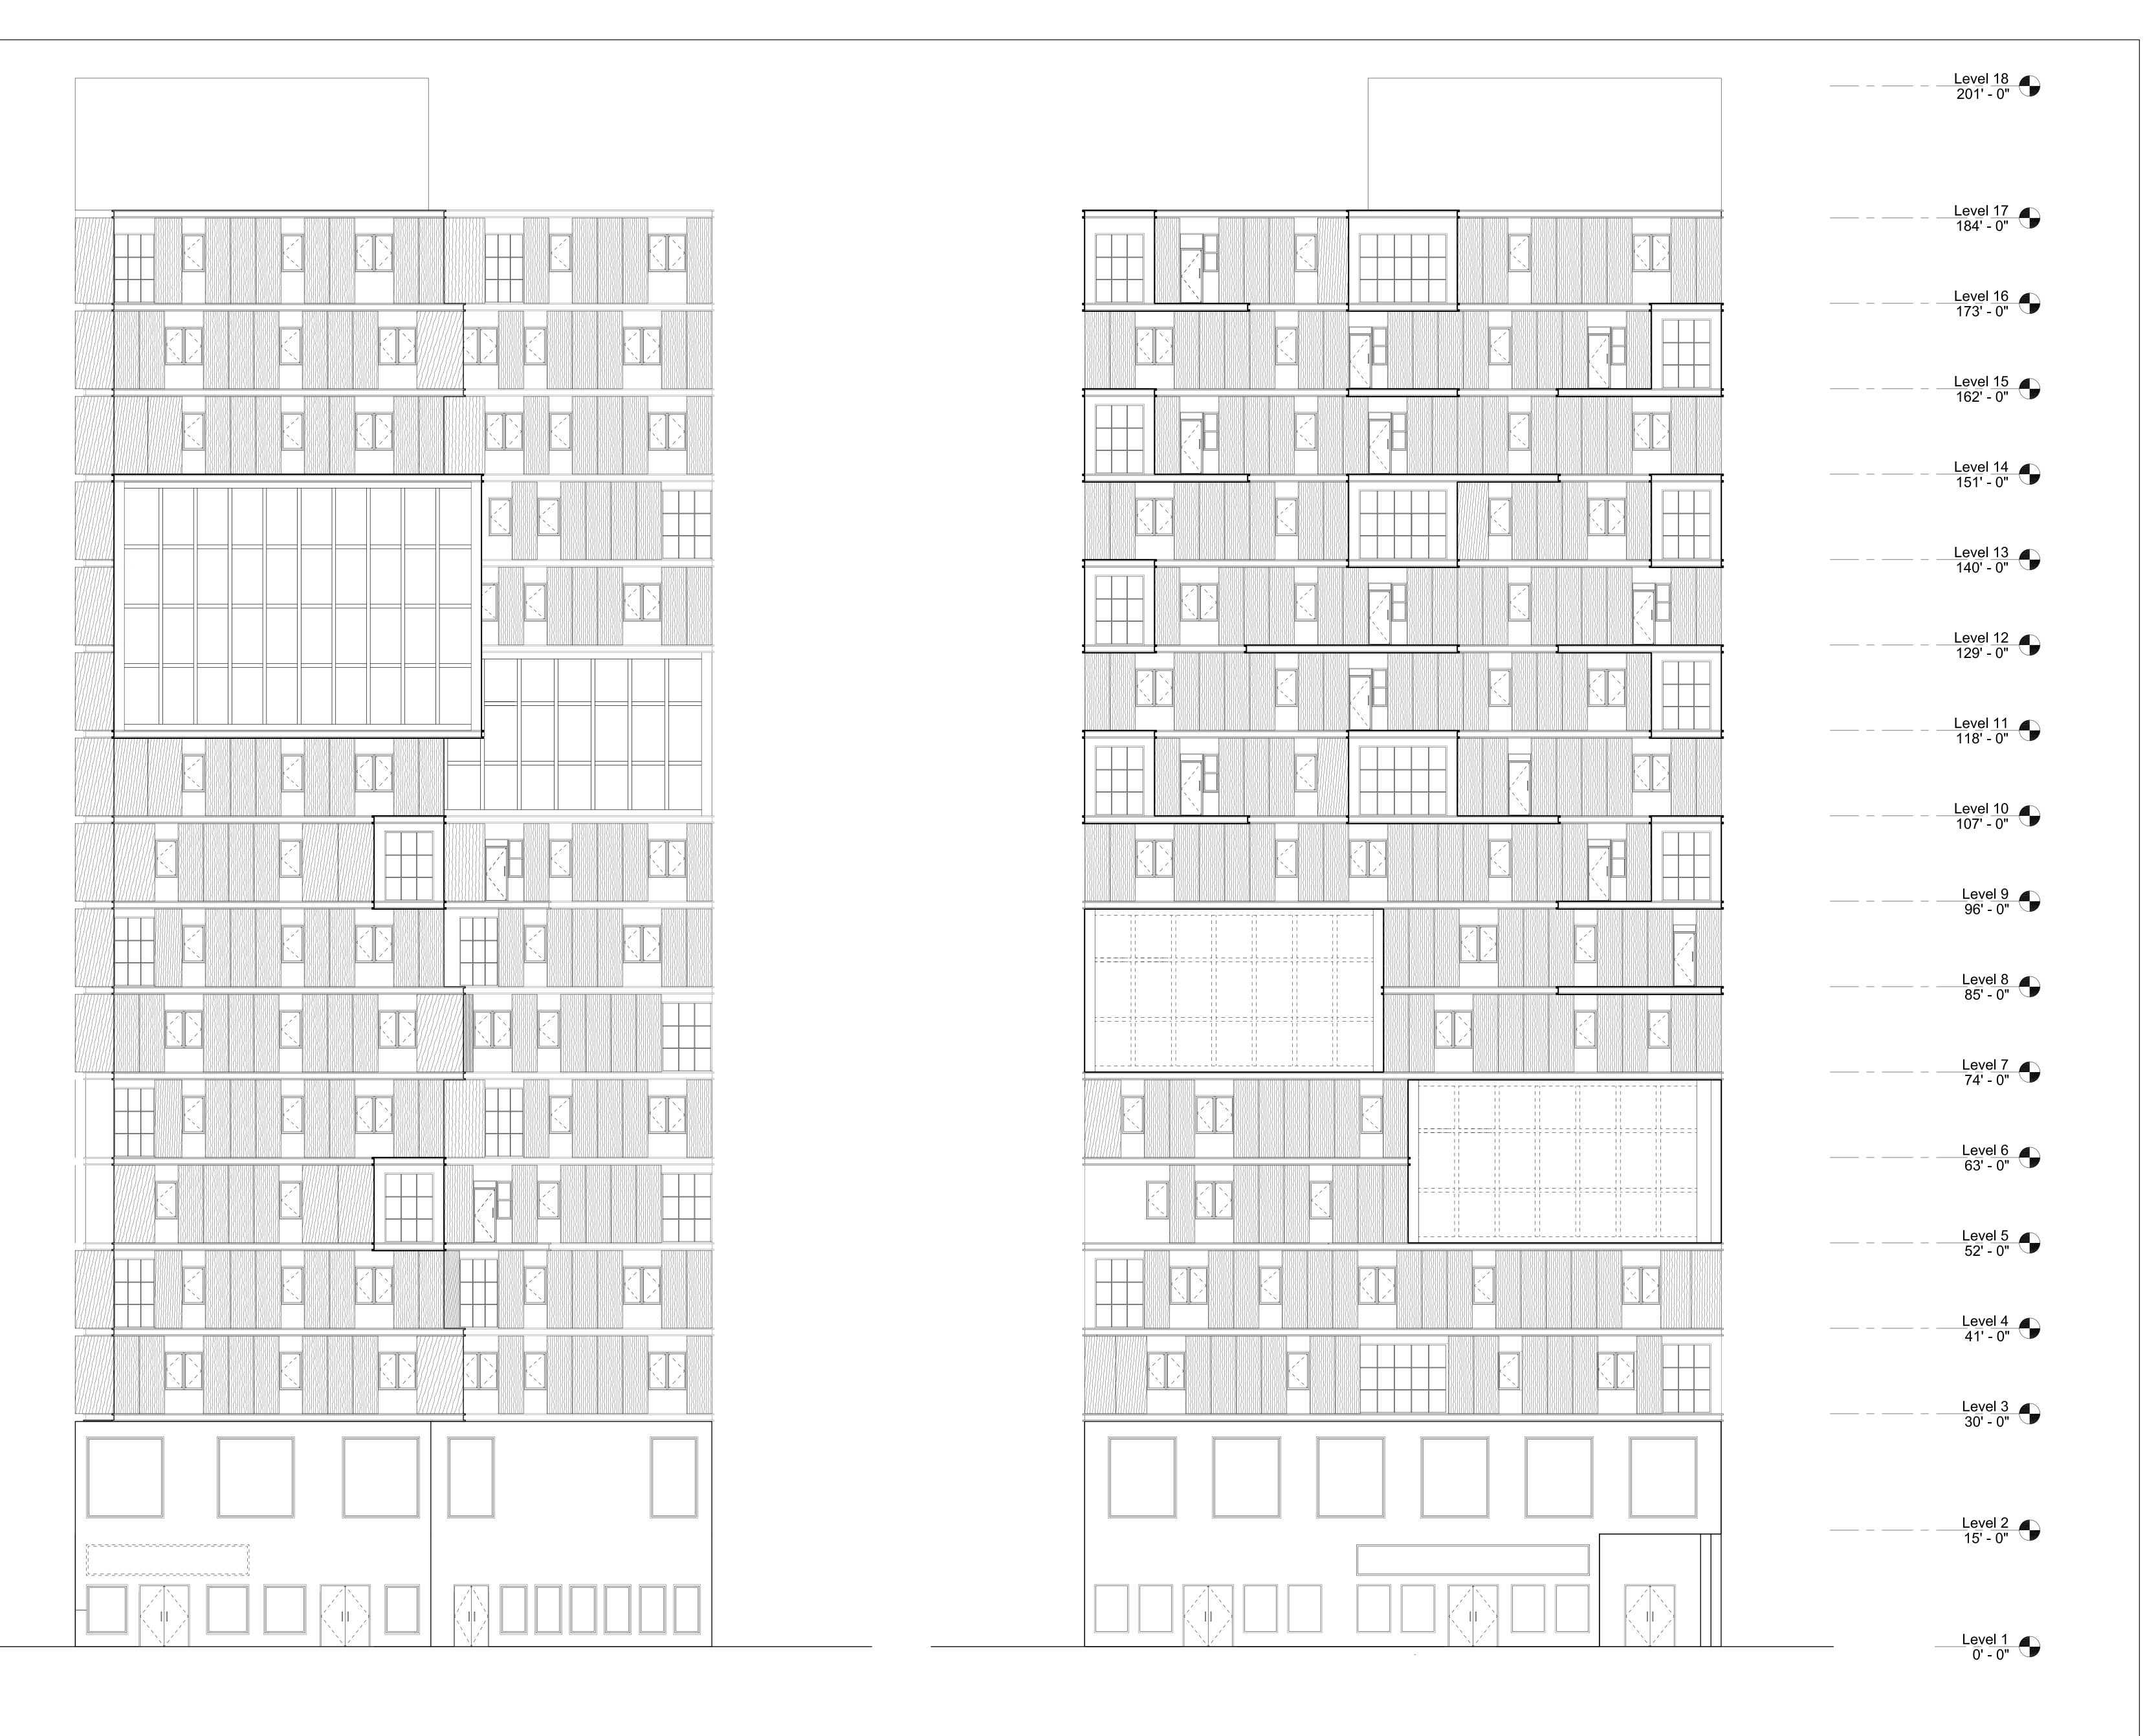
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Sheet Title: BUILDING ELEVATION (EAST)



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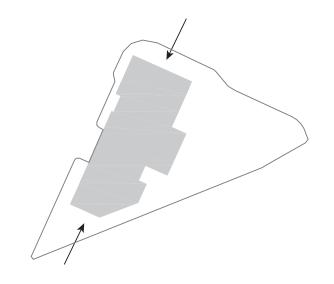
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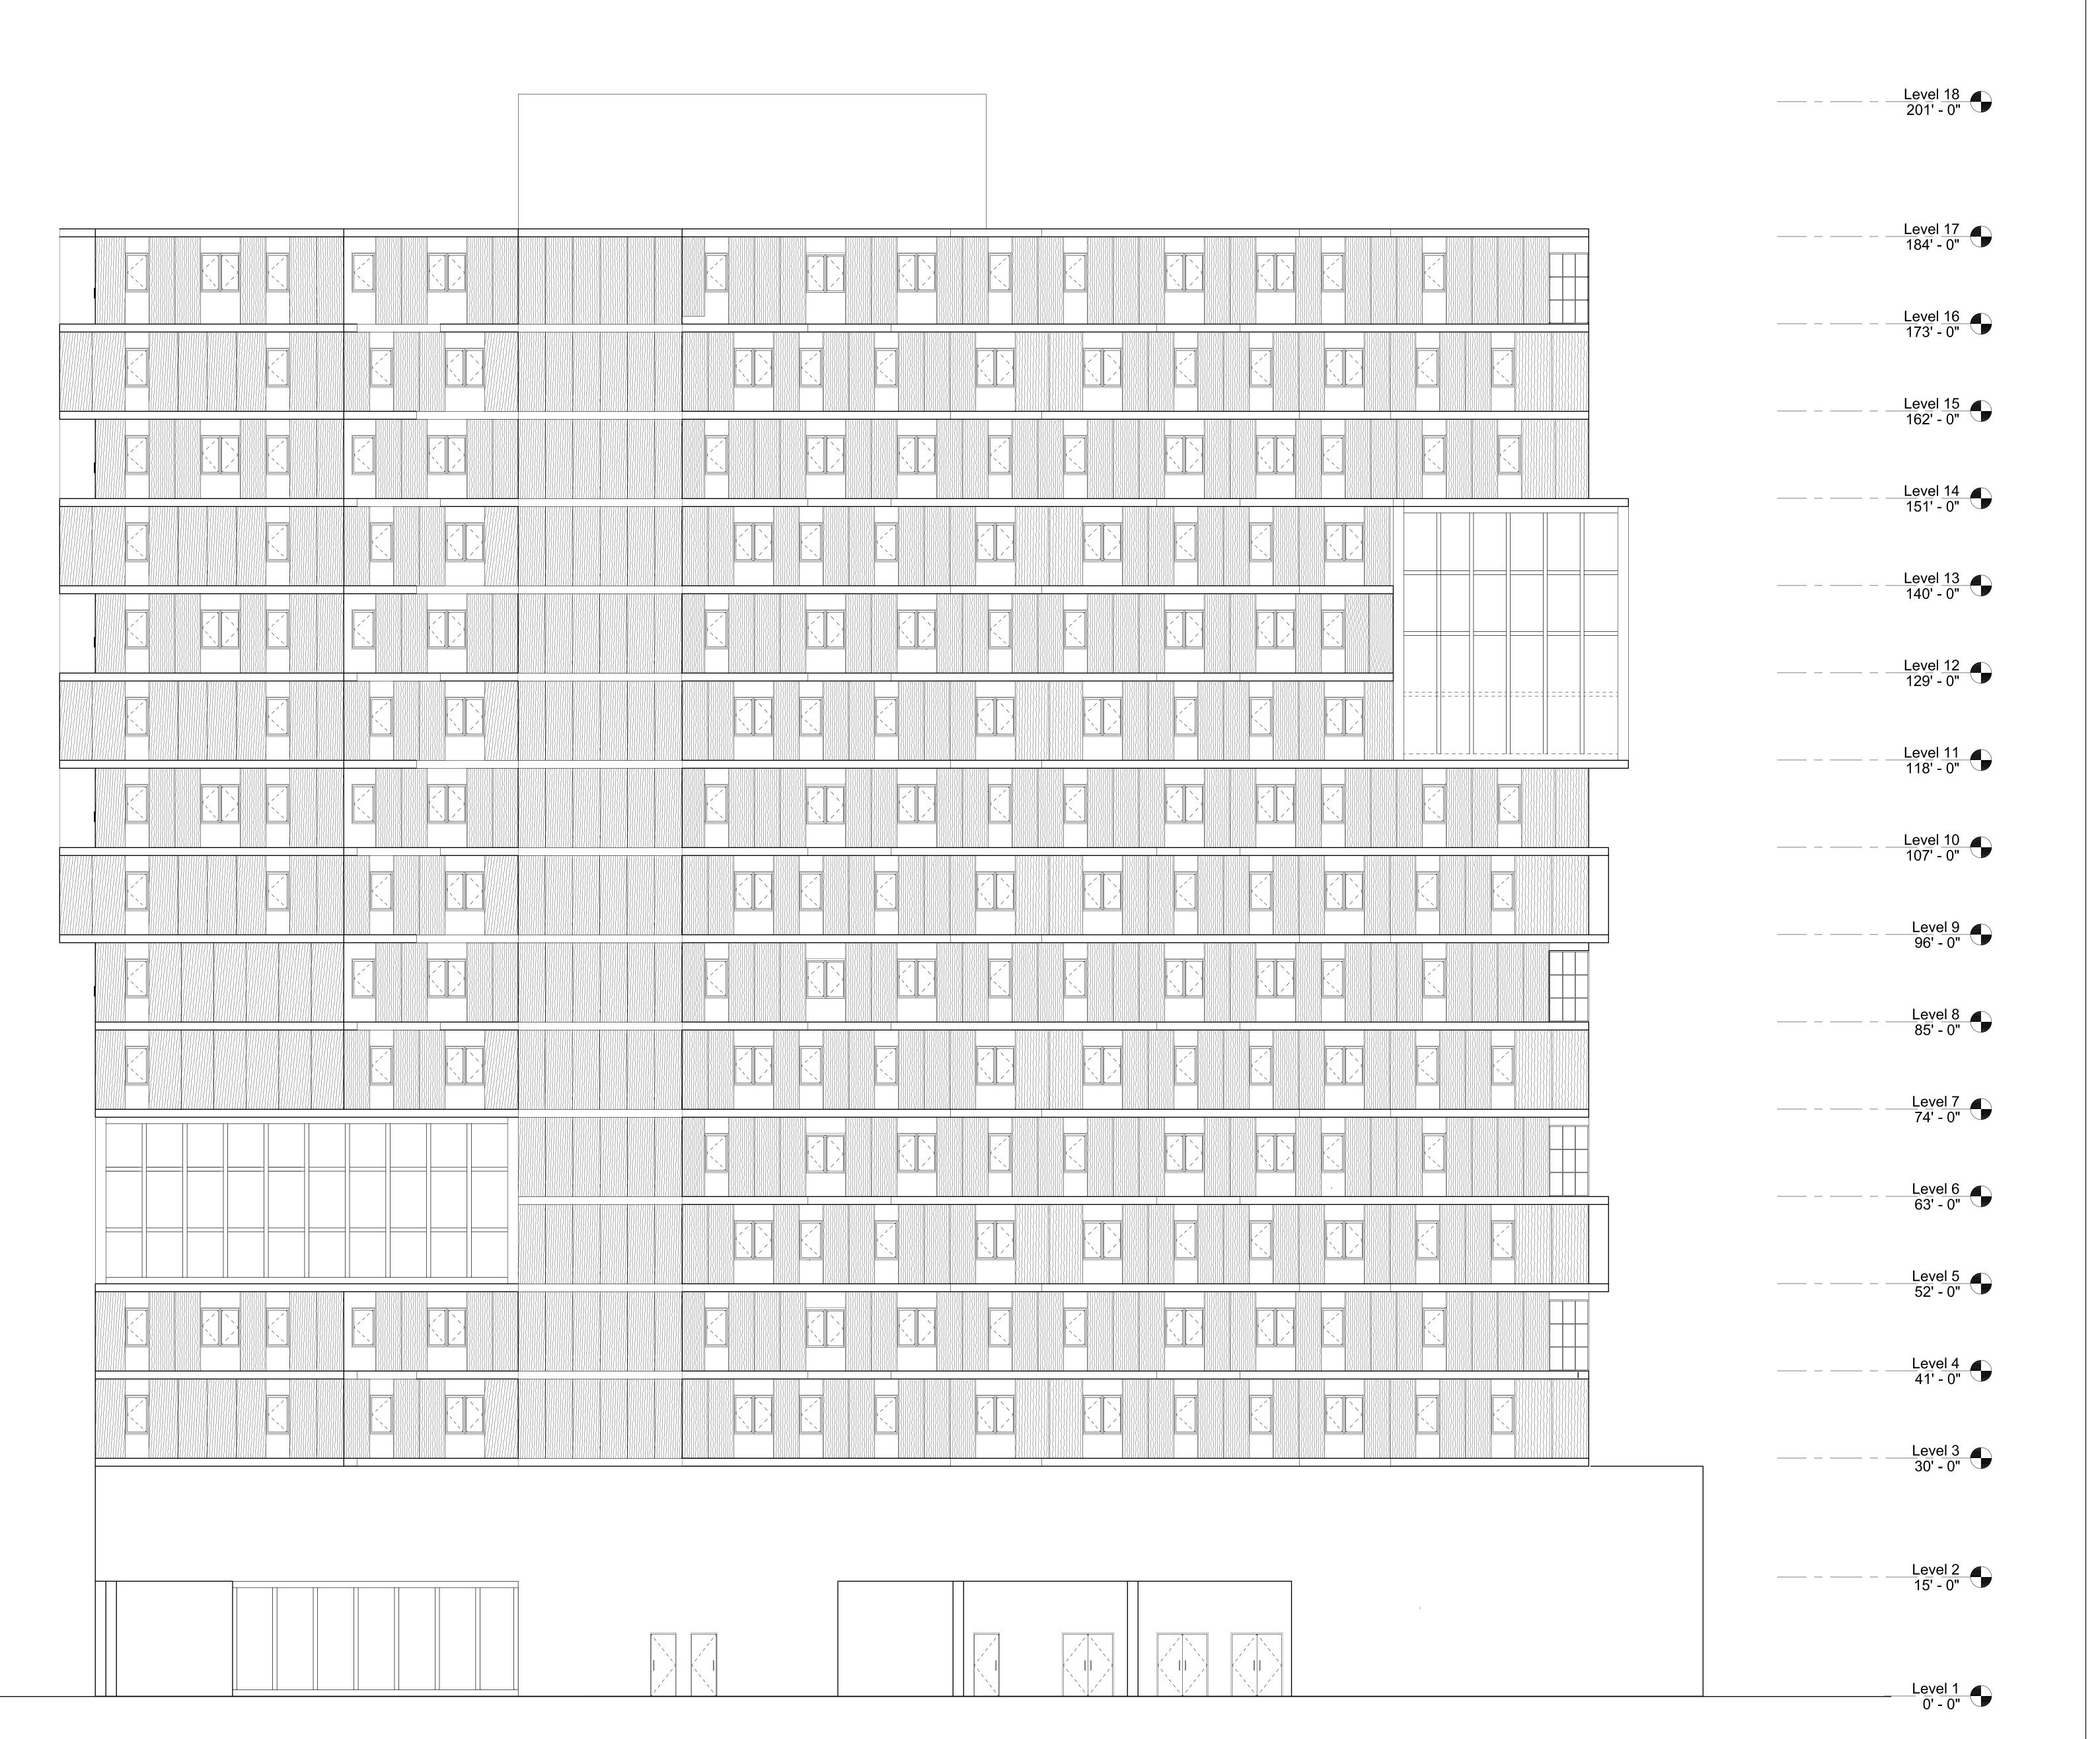
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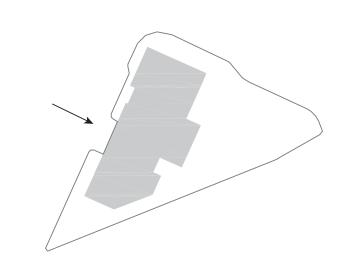
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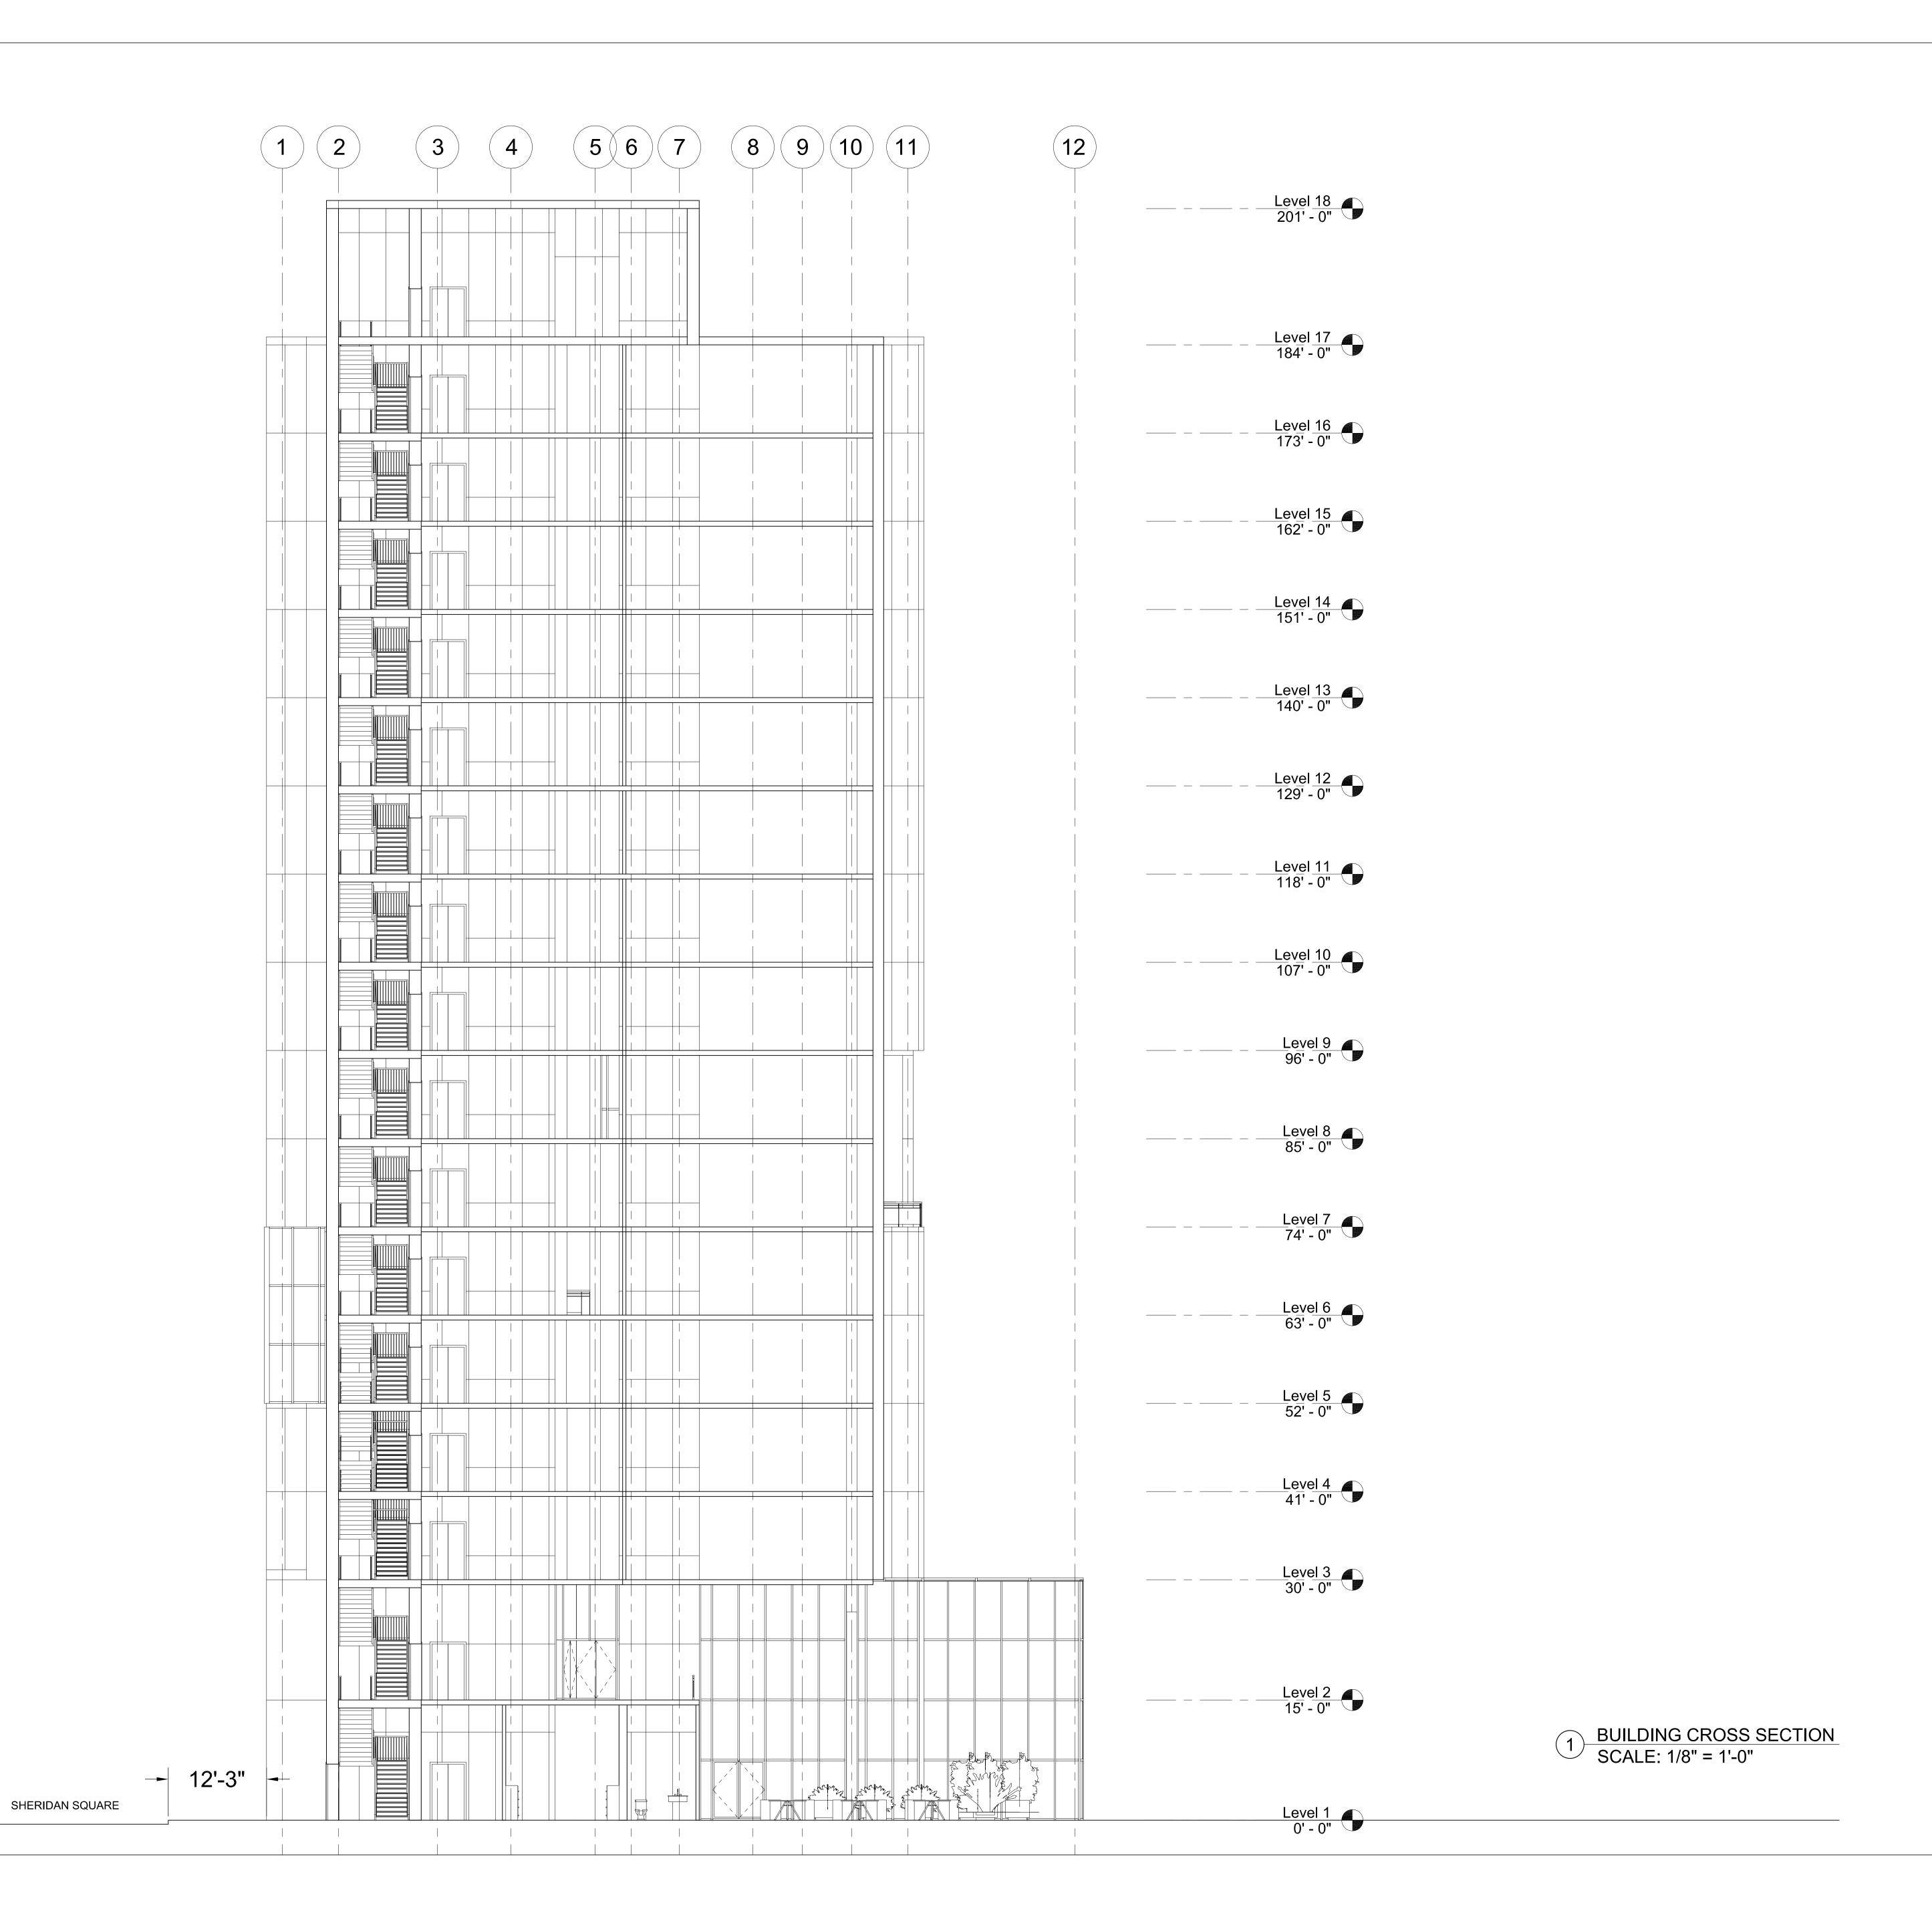
CONSULTANTS

Project No:

Drawn: Curran z. Date: 12/09/2019

Checked: Akhil B. Scale: 1/8" = 1'-0"

Sheet Title: BUILDING ELEVATION (WEST)



East Liberty, Pittsburgh, PA 15206

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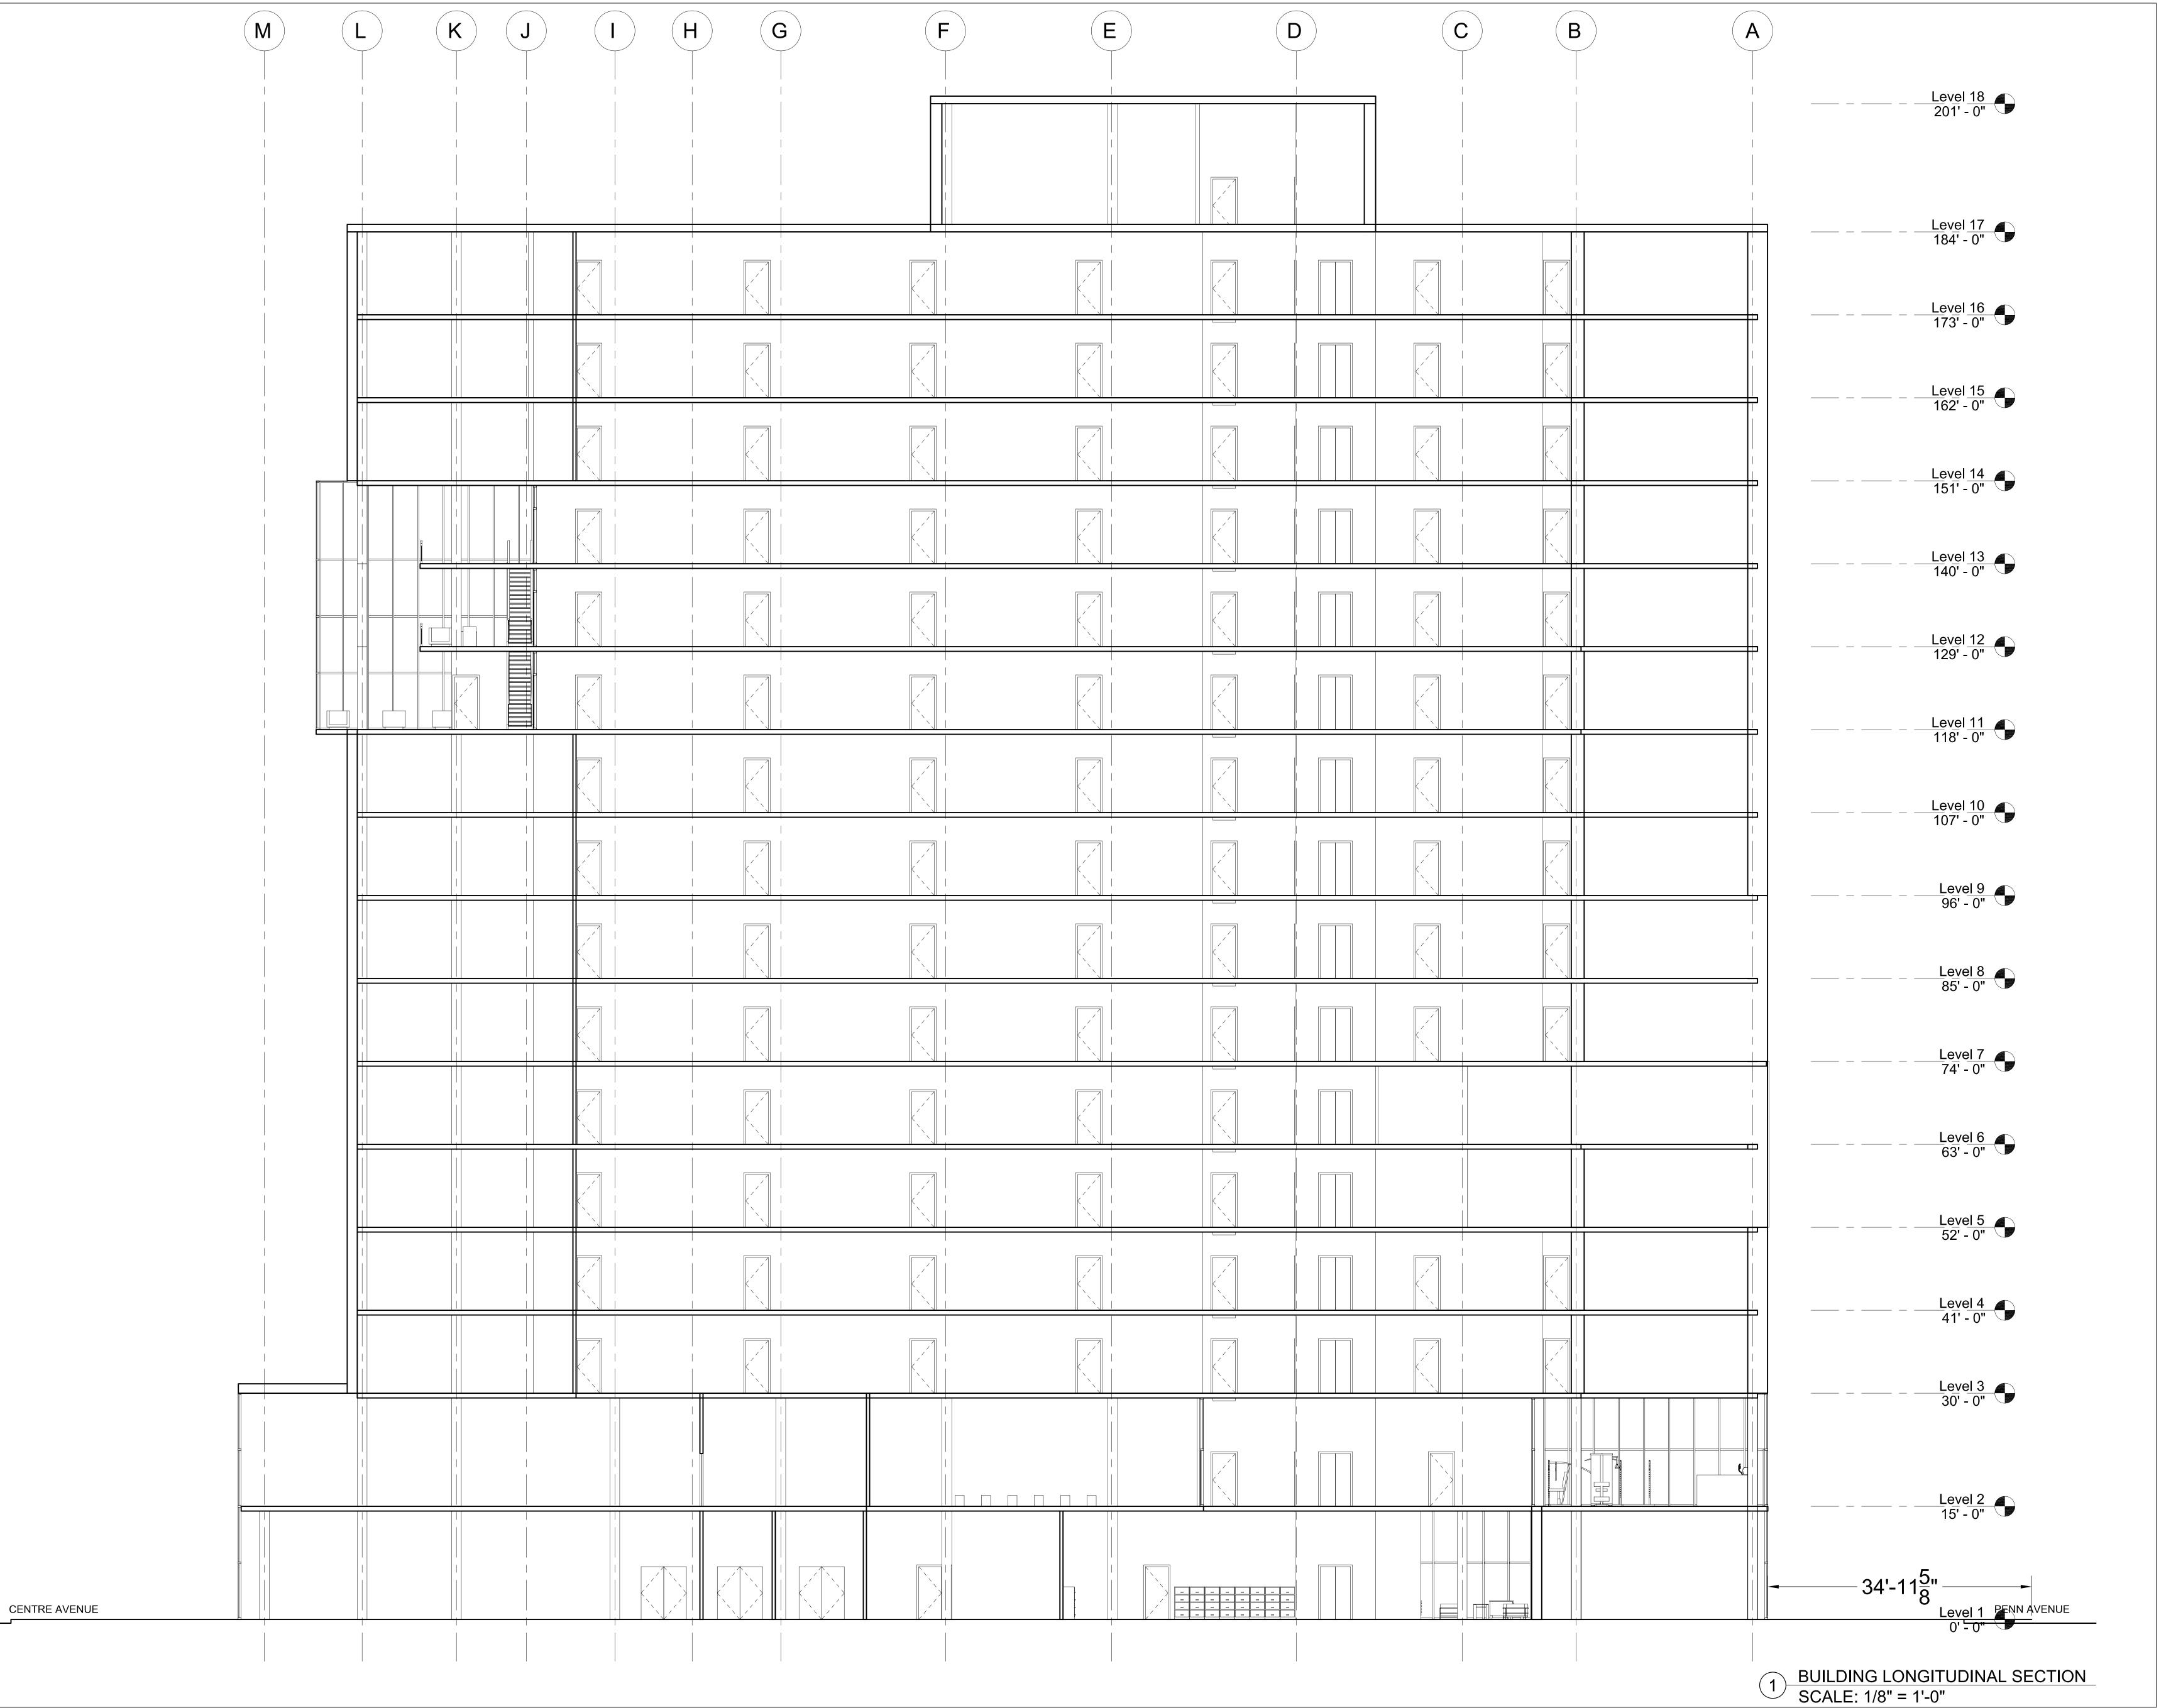
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CONSULTANTS

Project No:

Date: 12/09/2019 Checked: Akhil B. Scale: 1/8" = 1'-0"

Sheet Title: BUILDING CROSS SECTION



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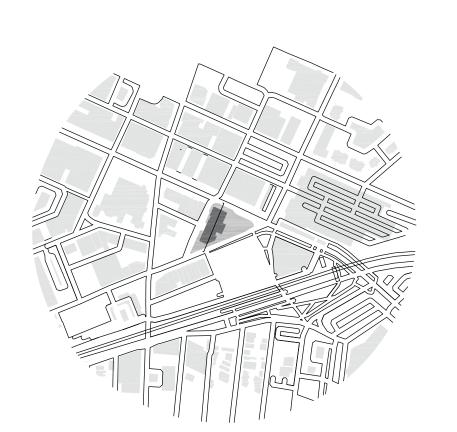
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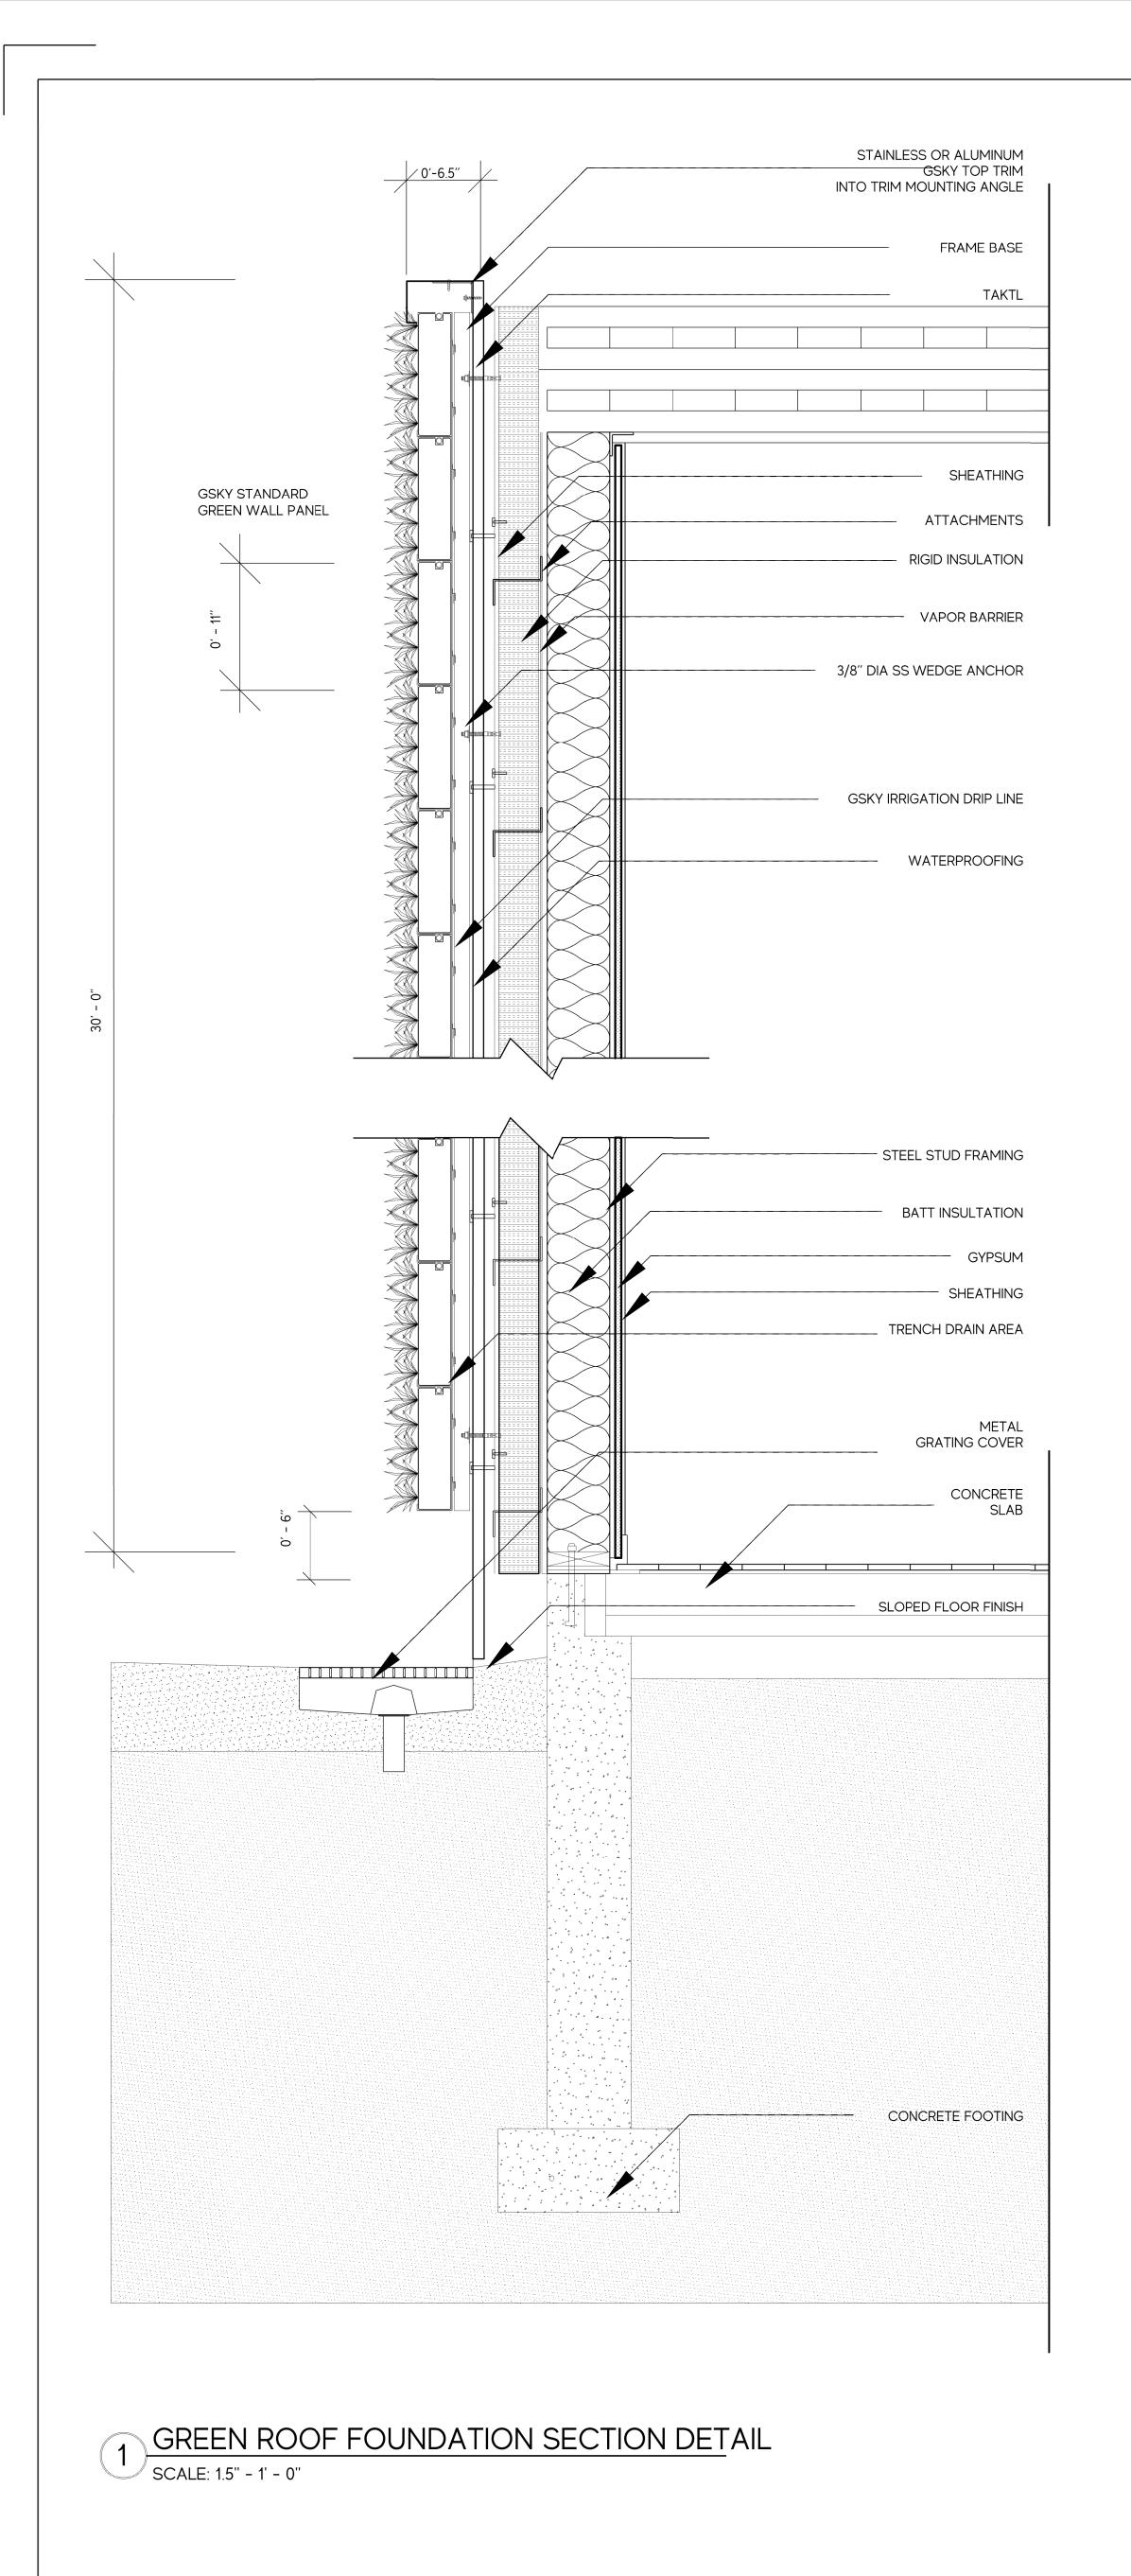
CONSULTANTS

Project No :

Drawn: Isabella O. Date: 12/09/2019


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Sheet Title: BUILDING ELEVATION (WEST FACADE)




- PHYTOREMDEIATION PLANTS MAX 3H:1L SLOPE CLEAR OUT ____ 3" MULCH UNDERDRAIN VALUE 2% MAX SLOPE 1:1 SLOPE FROM ASPHALT PAVEMENT/ STRUCTURAL COMPONENTS 30" BIORENTENTION SOIL 2" PERFORATED PIPE TRANSITION FROM SOLID TO PERFORATED PIPE TO OUTLET - 0.5% MIN SLOPE — NON-COMPACTED SUBGRADE

2 BIOFILTRATION SECTION
SCALE: 3/4" - 1' - 0"

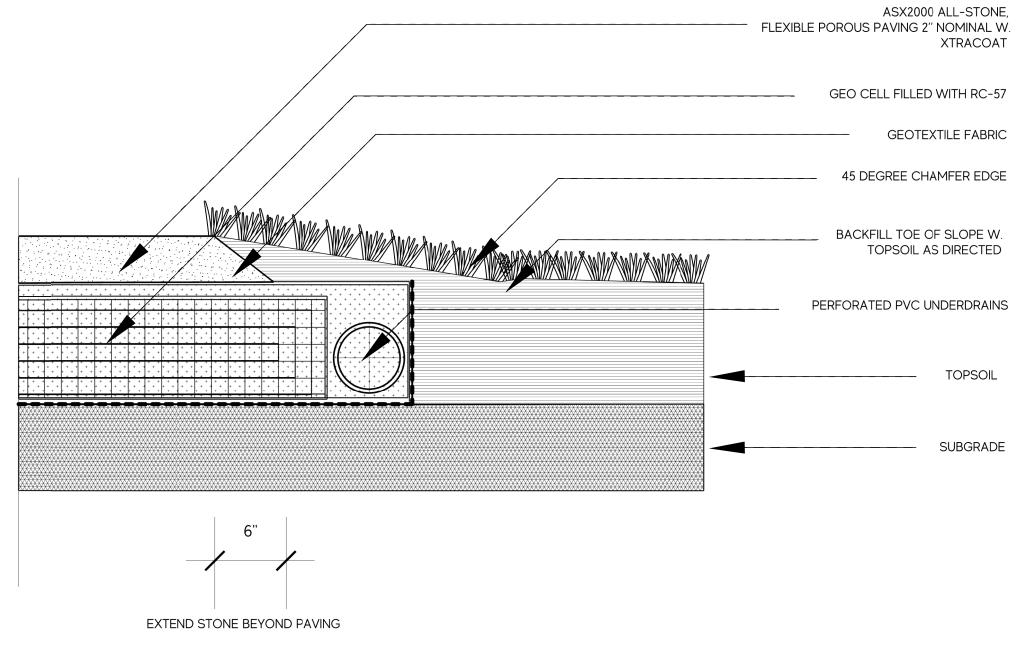

3 POROUS PAVEMENT SECTION

SCALE: 1.5" - 1' - 0"

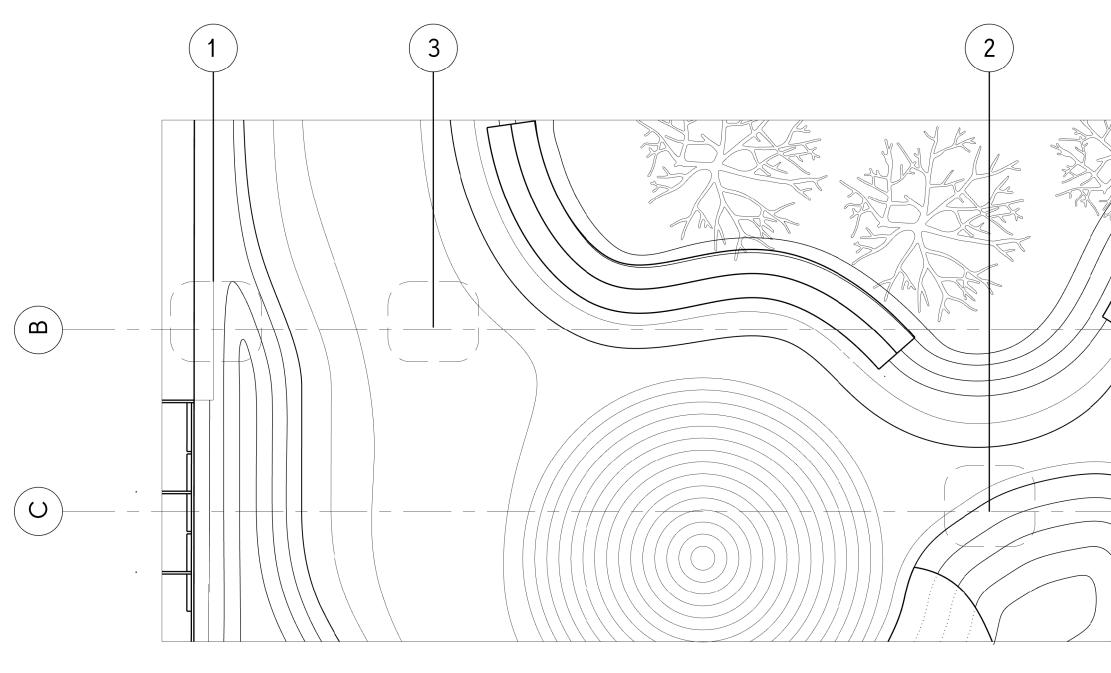

4 ENLARGED PARK SITE PLAN
SCALE: 1/8" - 1' - 0"

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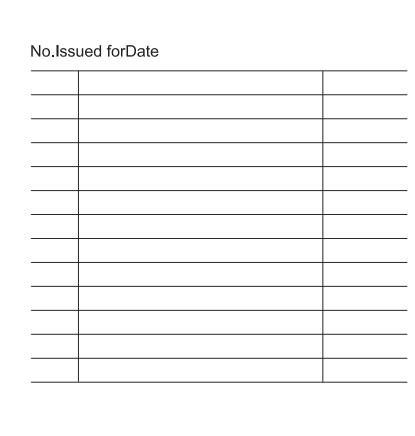
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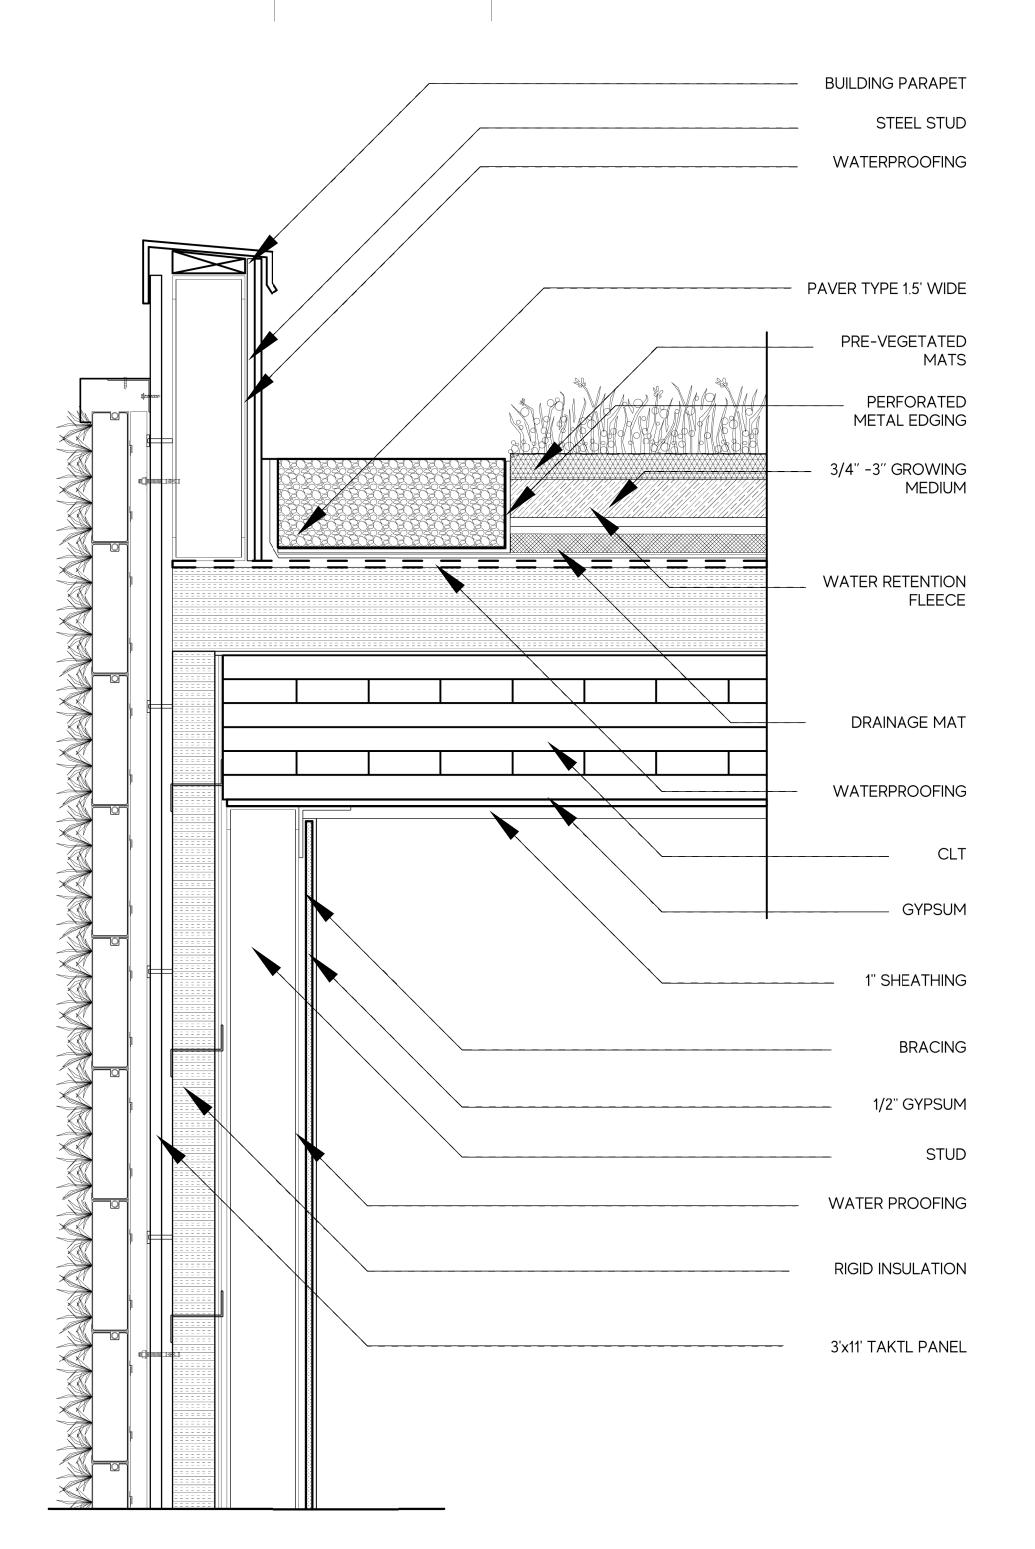
CONSULTANTS

Project No :

Drawn : Longney L. Date : 12/09/2019


Checked: Akhil B. Scale: VARIES

Sheet Title: SYSTEMS SHEET: SITE DETAILS




<0' - 18">

PODIUM GREEN ROOF DETAIL SECTION SCALE: 1.5" - 1' - 0"

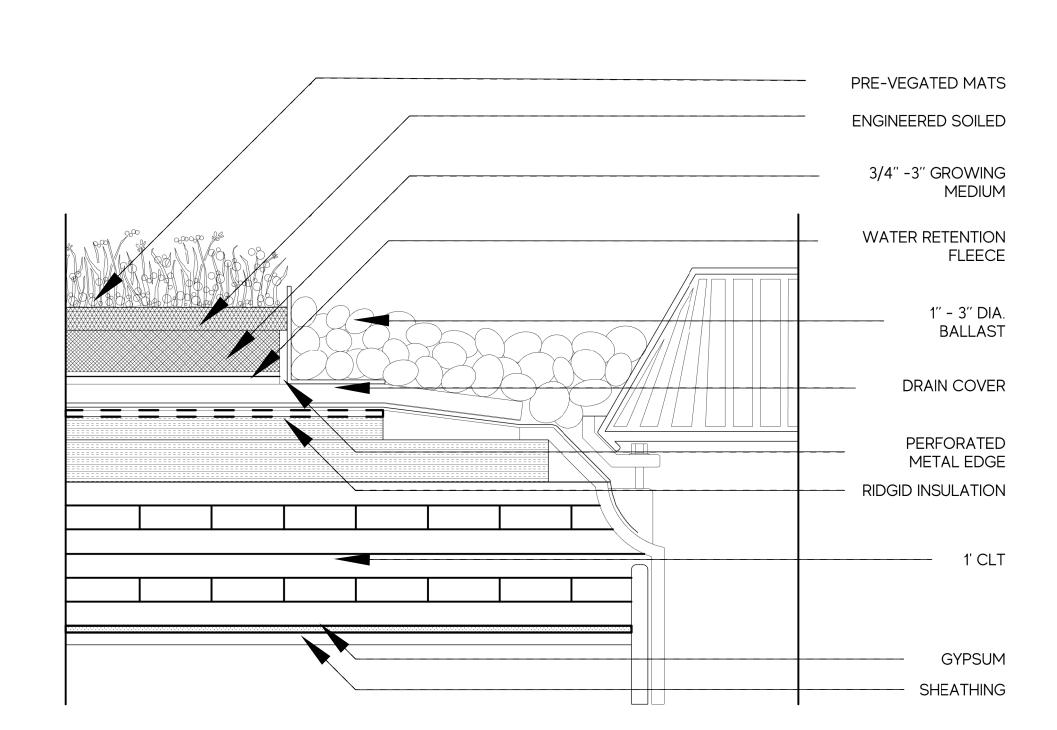


GREEN ROOF DRAINAGE SECTION DETAIL

SCALE: 1.5" - 1' - 0"

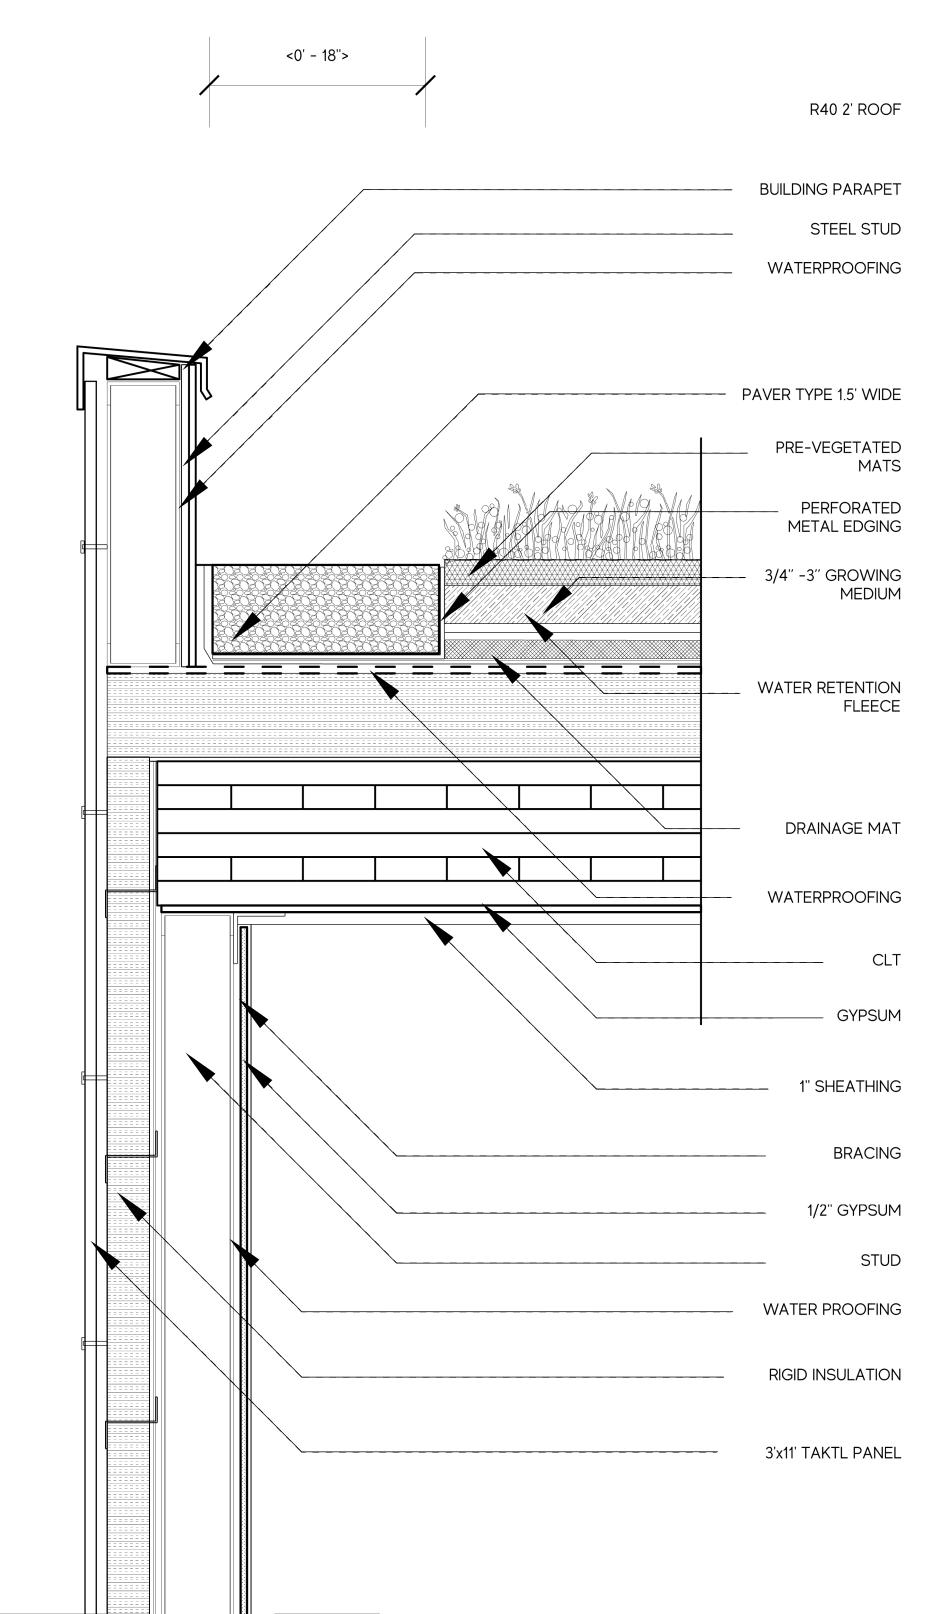

2 RESIDENTIAL GREEN ROOF DETAIL SECTION

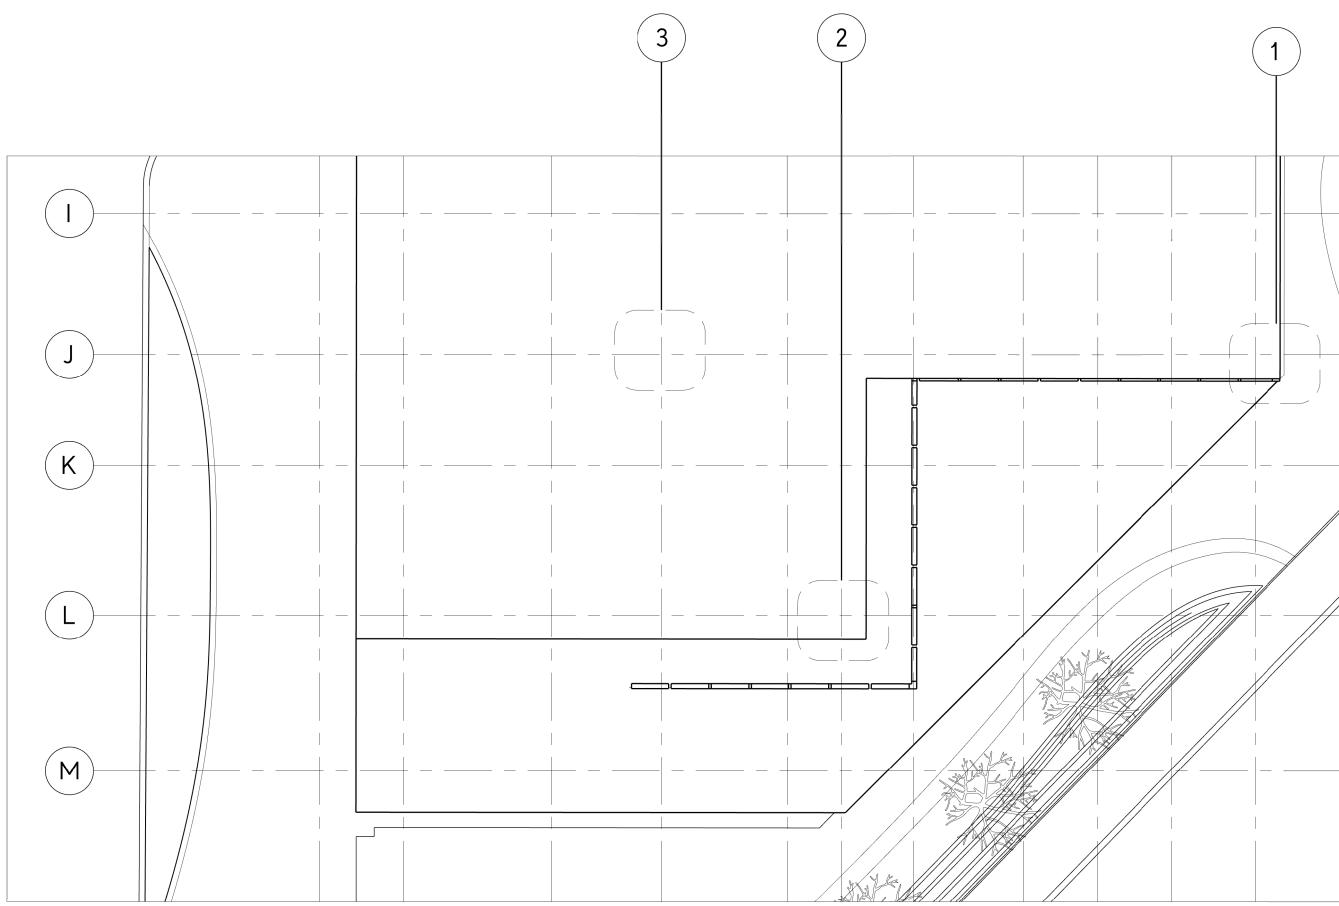

4 ENLARGED PODIUM PLAN
SCALE: 1/8" - 1' - 0"

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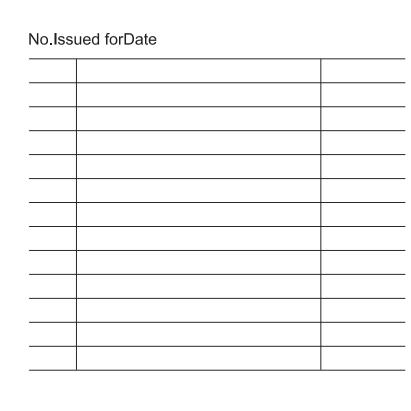
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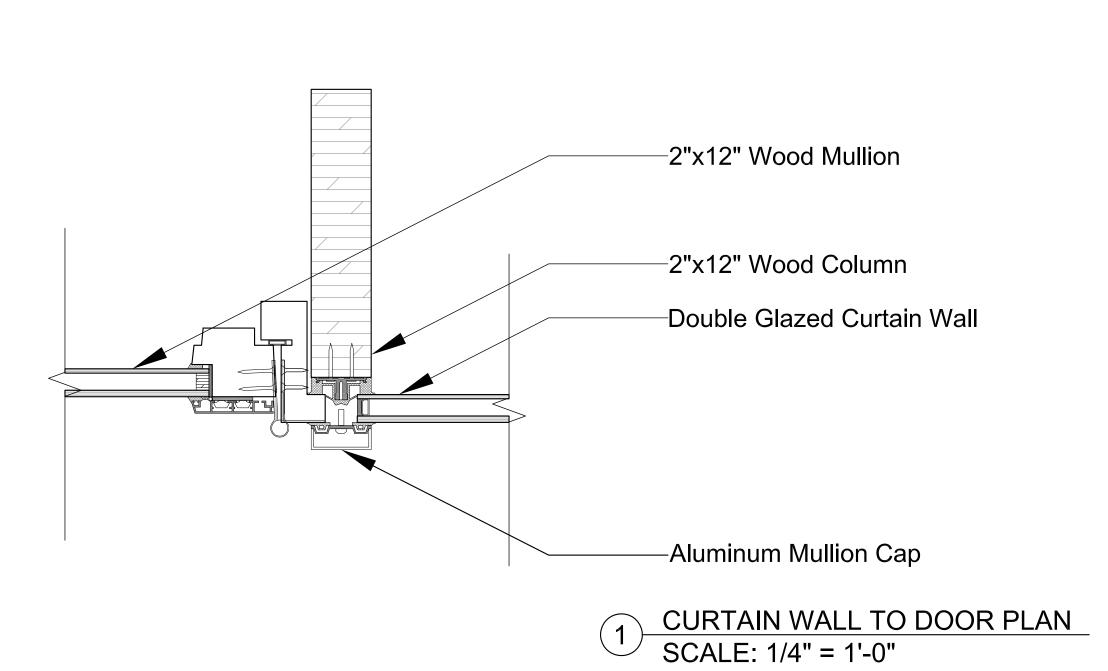
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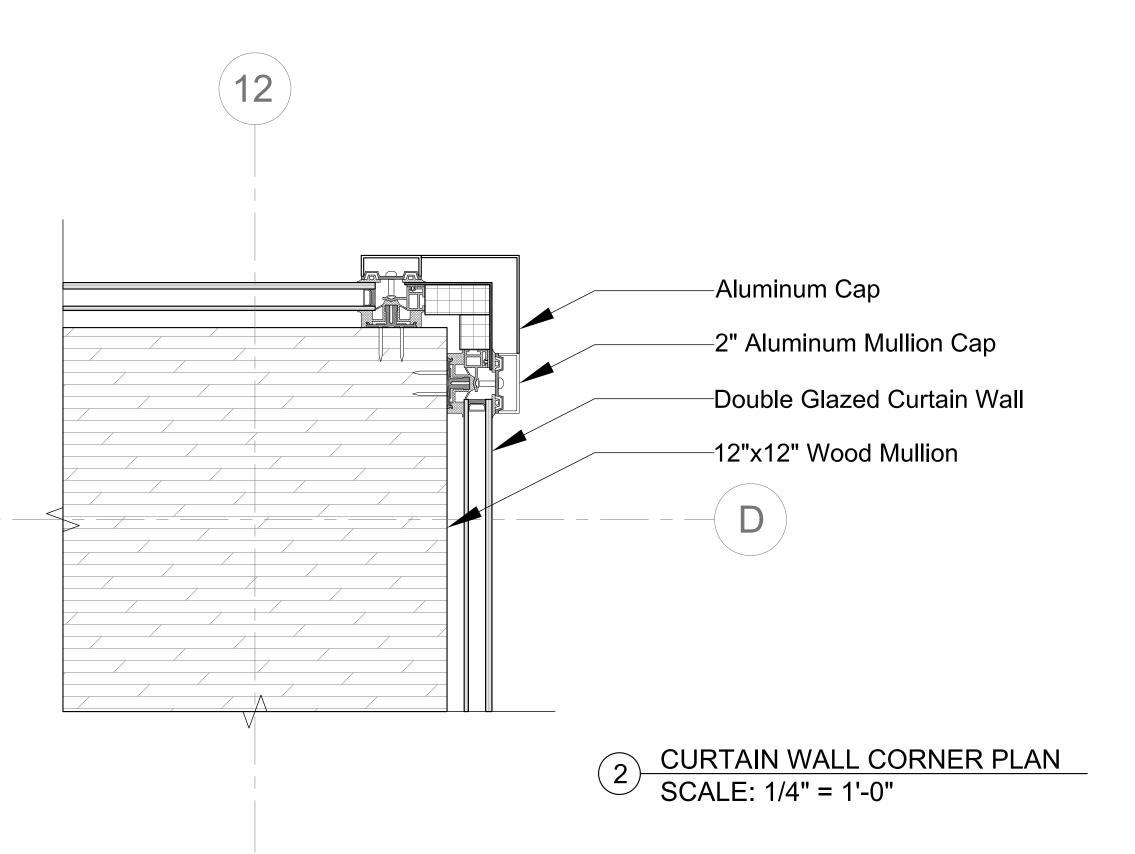
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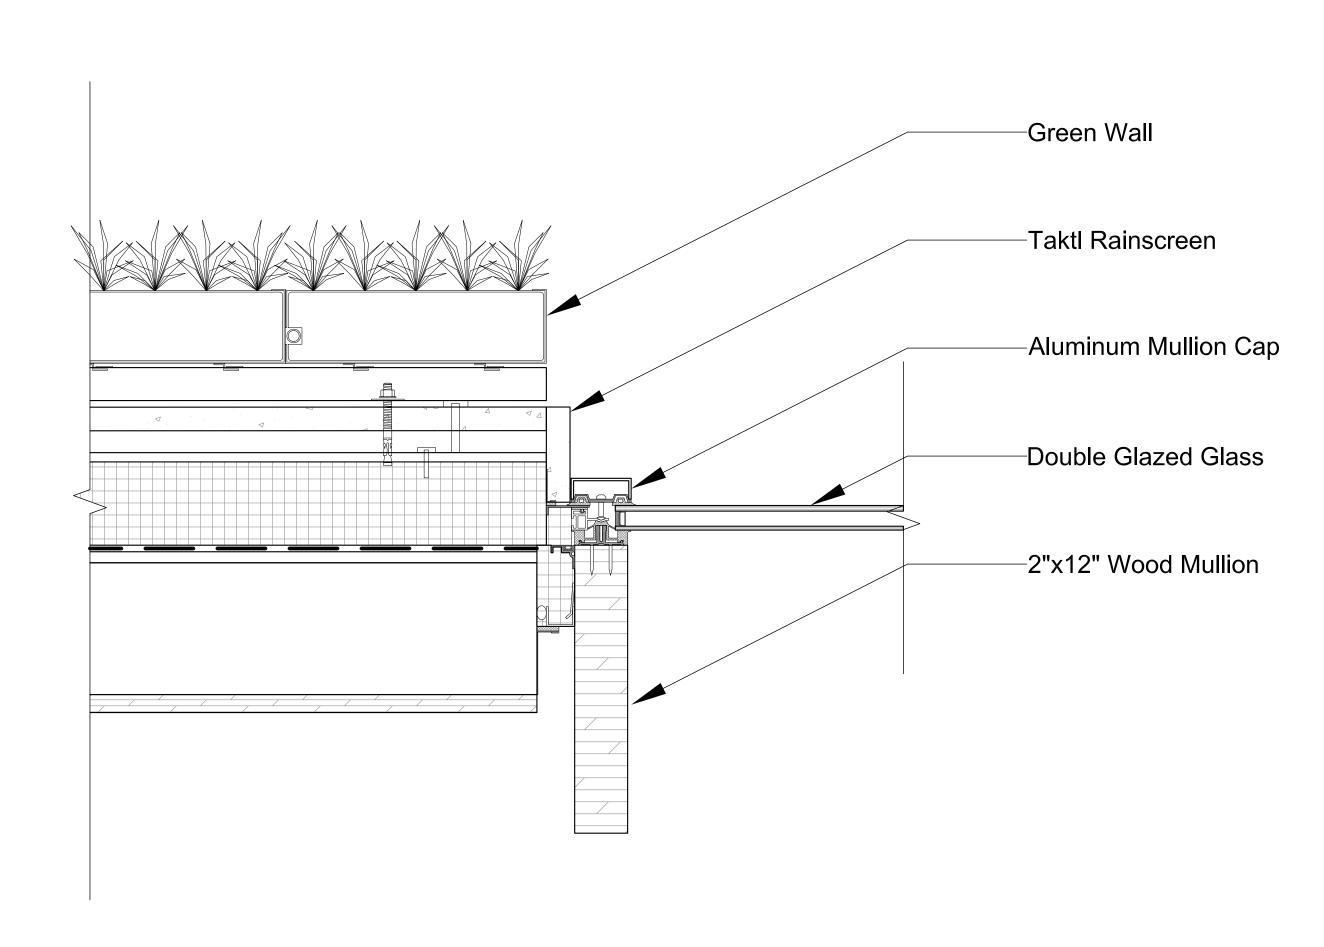
Project No:

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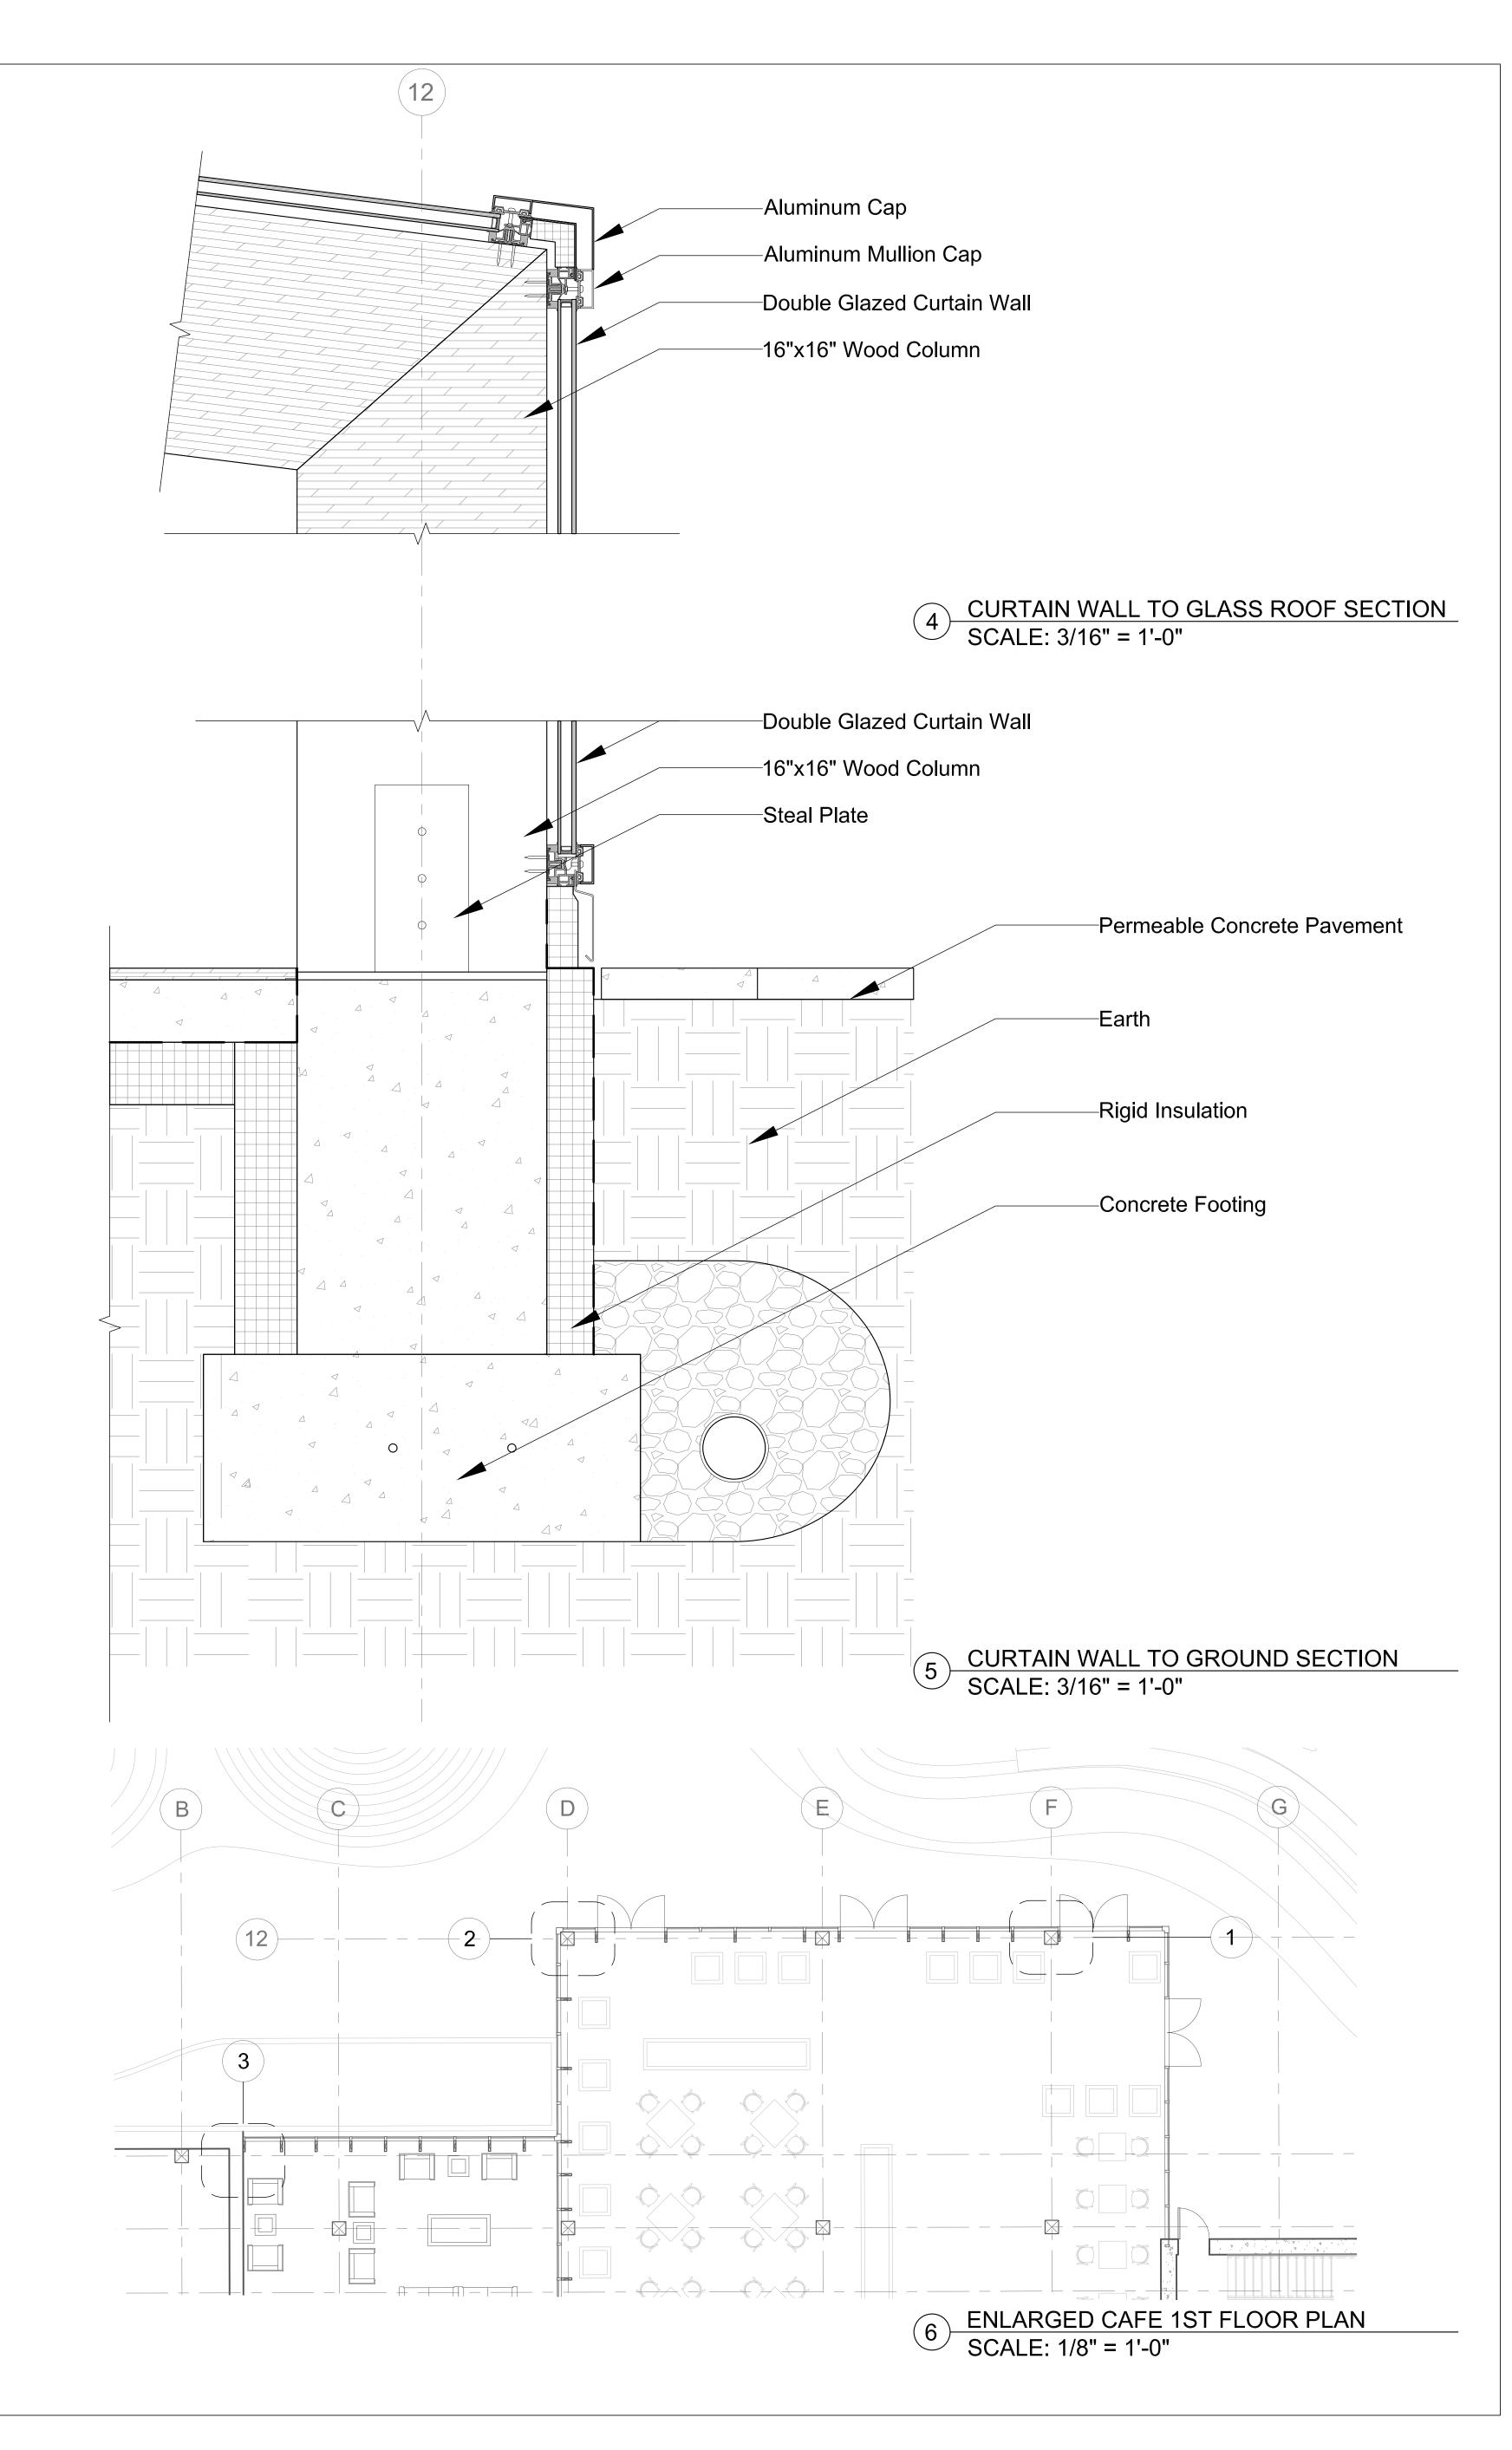
Sheet Title: SYSTEMS SHEET: GREEN ROOF







3 CURTAIN WALL TO GREEN WALL PLAN SCALE: 1/4" = 1'-0"



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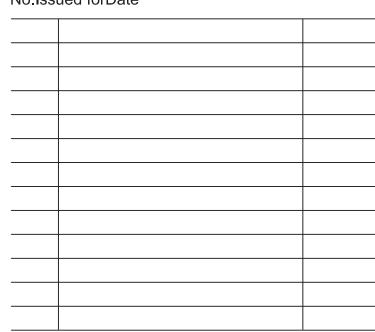
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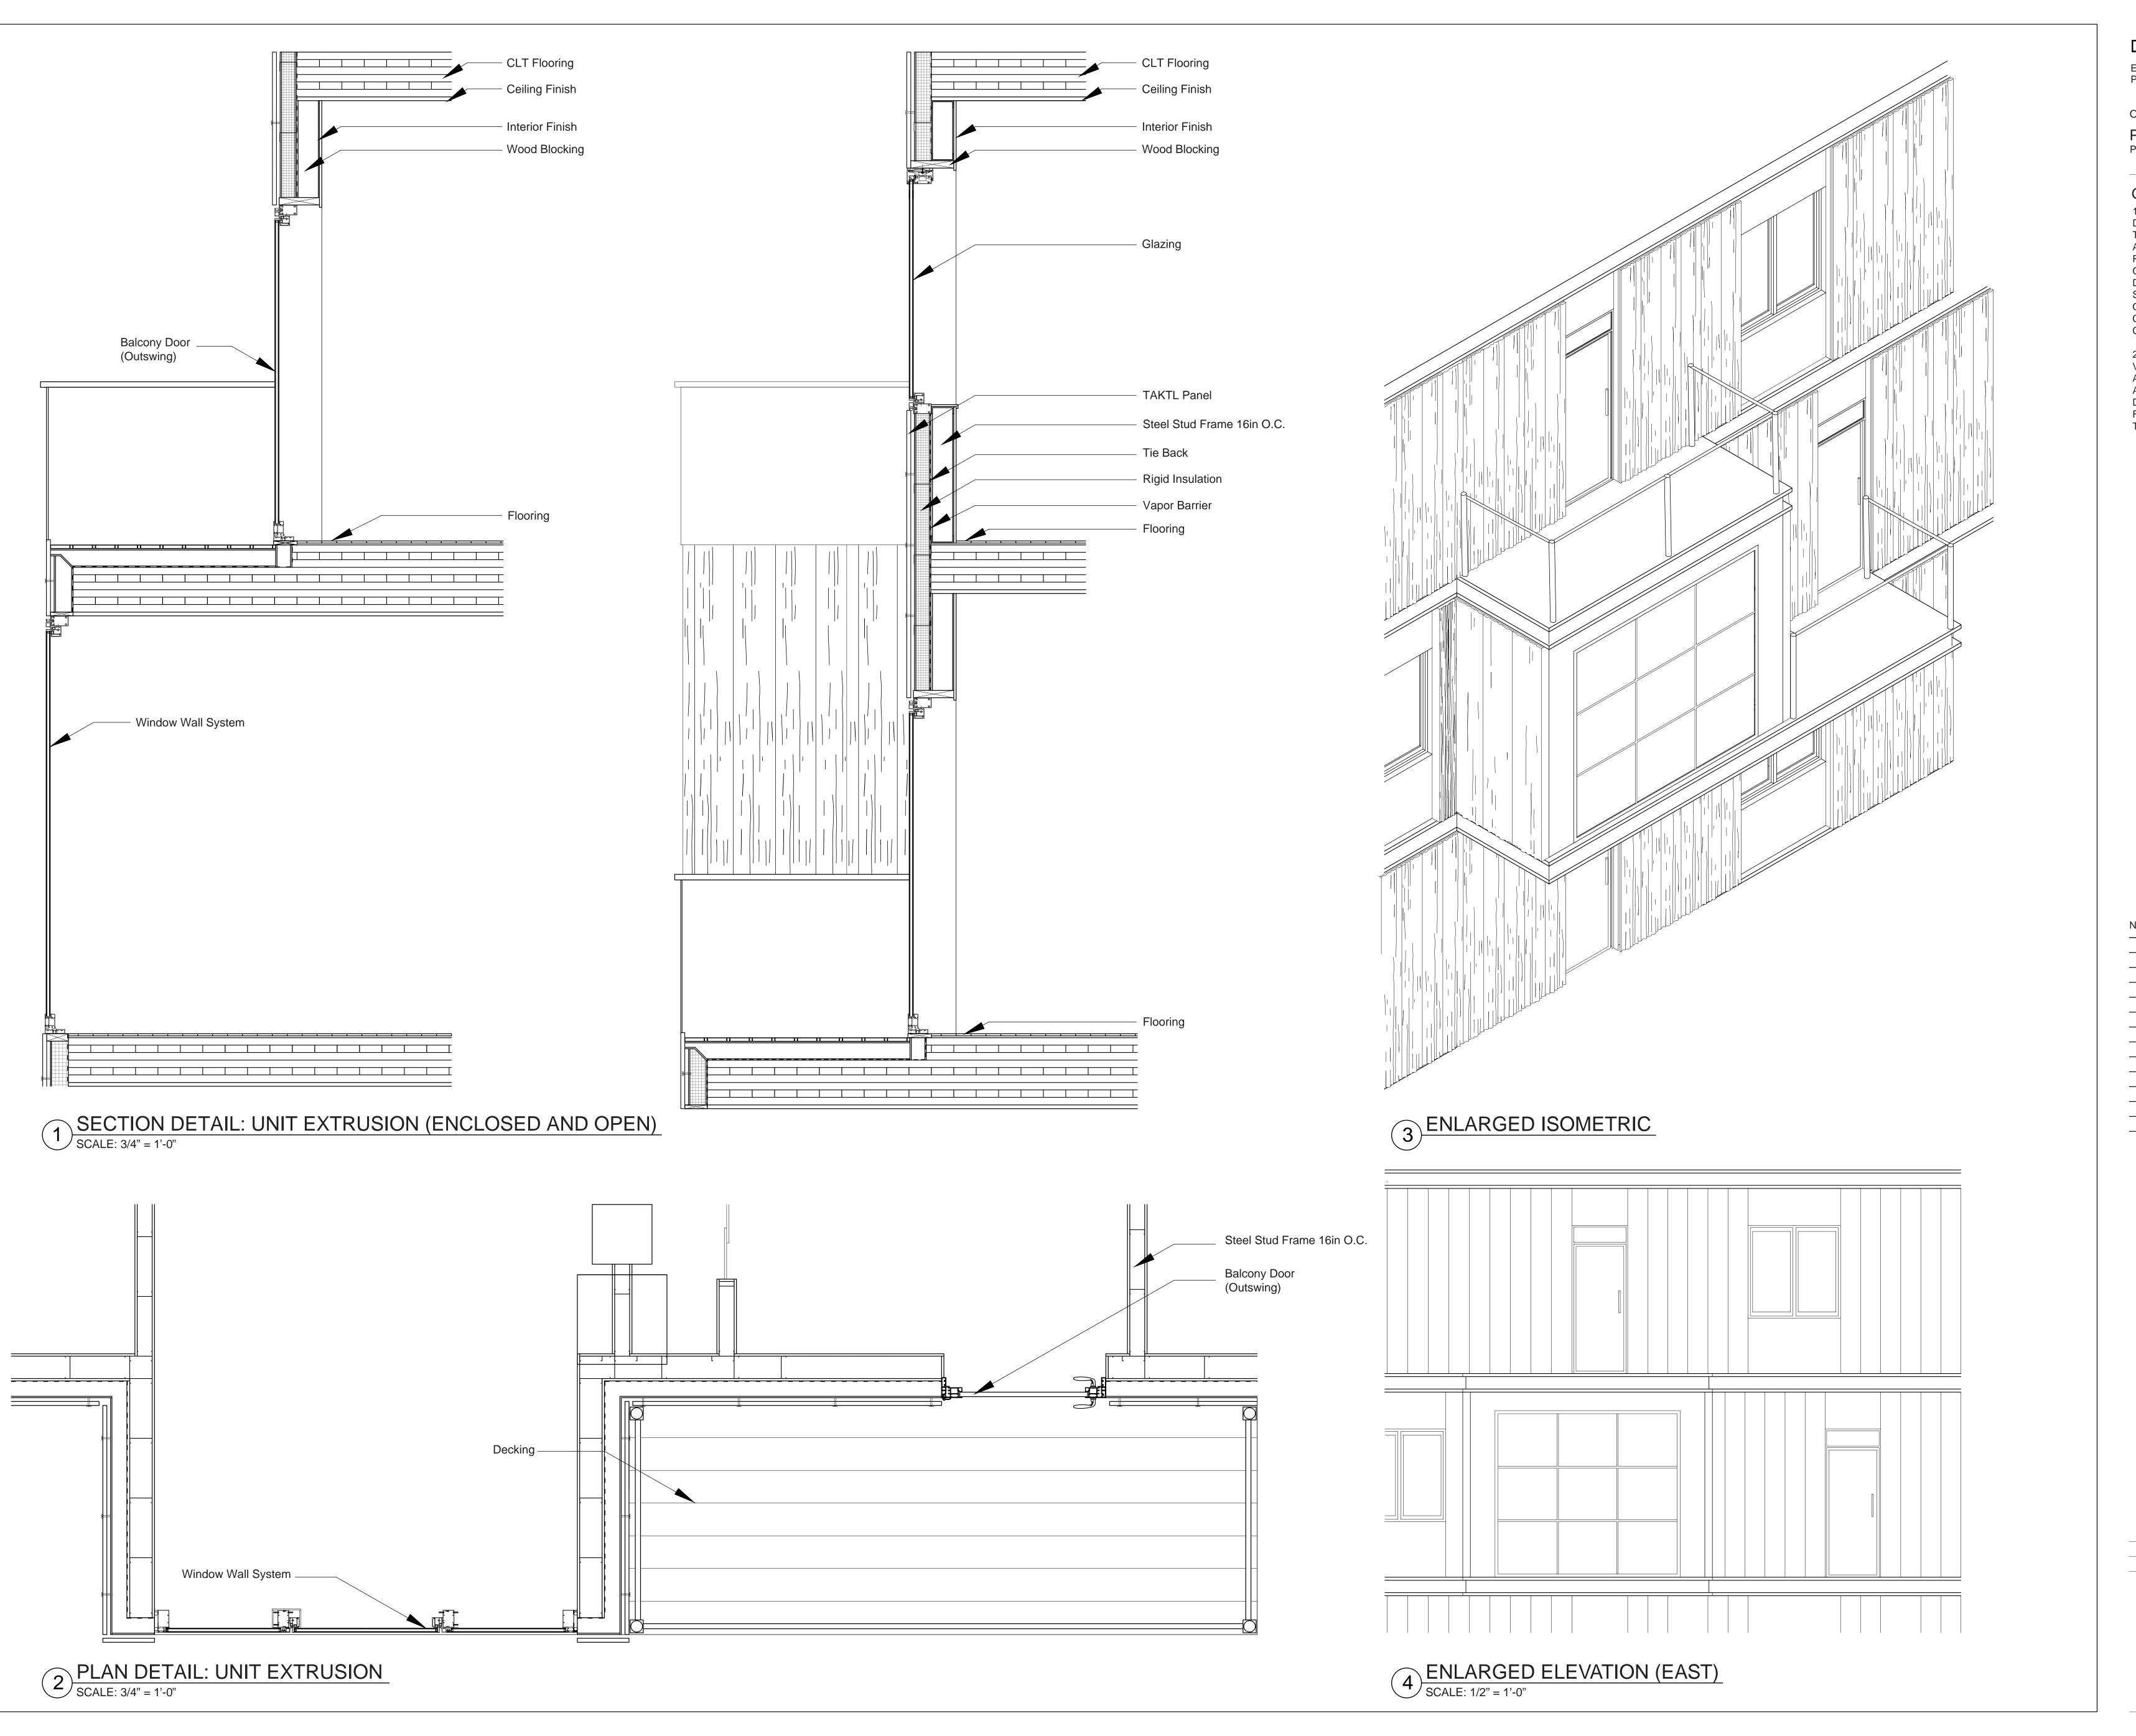
CONSULTANTS

Project No :

Drawn: Isabella O. Date: 12/09/2019

Checked: Akhil B. Scale: VARIES

Sheet Title: SYSTEMS SHEET: CURTAIN WALL



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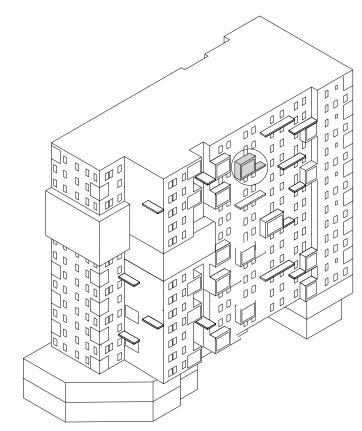
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CONSULTANTS

Project No :

Drawn : Chitika V. Date : 12/09/2019

Checked : Akhil B. Scale : VARIES

Sheet Title : SYSTEM SHEET: FACADE